


DOUBLE-HOUSE

DESIGNED BY:
ADAM BERMAN
SIOBHAN FINLAY
RICE ARCHITECTURE CONSTRUCT

DESIGN INTENT

CLADDING MATERIALS:

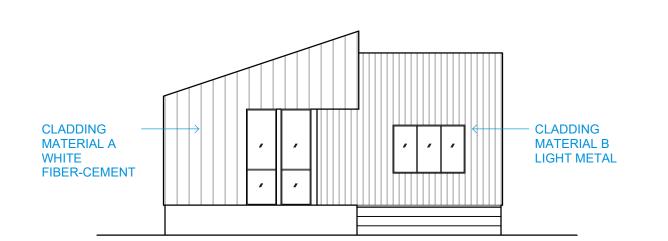


THE DESIGN INTENT PREFERENCES SIMPLE, DURABLE MATERIALS WITH LIGHT COLORS TO REDUCE HEAT GAIN AND SAVE ENERGY, PREFERABLY WHITE FIBER-CEMENT FOR THE ENTRY/KITCHEN AND A SLIGHTLY DARKER CORRUGATED METAL FOR THE LIVING/BEDROOM RECESSED VOLUME.

RECOMMENDED COLOR PALETTE:




FIBER CEMENT PANEL PAINTED WHITE

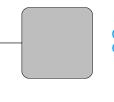

CORRUGATED METAL GALVALUM OR LIGHT GRAY



FIBER CEMENT PANEL PAINTED WHITE

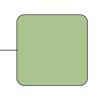

CORRUGATED METAL LIGHT GREEN



FIBER CEMENT PANEL PAINTED WHITE



DESIGN NARRATIVE:

DOUBLE-HOUSE IS COMPOSED OF TWO RECTANGULAR VOLUMES, EACH WITH A UNIQUE MATERIAL AND SPATIAL CHARACTER. THE VOLUMES ARE OFFSET TO PRODUCE A SERIES OF SPACES WITH INCREASING LEVELS OF PRIVACY, INCLUDING TWO OUTDOOR PORCHES ALONG THE FRONT AND REAR. THE FACADE FURTHER EMPHASIZES THESE DUAL VOLUMES WITH JEXTAPOSING ROOFLINES AND A LIGHT CONTRAST IN MATERIAL EXPRESSION. INSIDE, PROGRAMMATIC SHIFTS DIVIDE THE TWO RECTANGULAR VOLUMES INTO THREE ZONES: (1) AN ENTRY THRESHOLD, (2) A SHARED LIVING SPACE, AND (3) A PRIVATE SLEEPING AREA. THE ADU'S ROOFLINES CREATE A LAYERED EXPERIENCE THAT LENDS AN INTIMATE QUALITY TO THE SHARED LIVING, DINING, AND KITCHEN AREA.

BASIS OF DESIGN:

THE FOLLOWING SERVED AS THE BASIS OF DESIGN AND MAY BE SUBSTITUTED WITH PRODUCTS OF EQUIVALENT PERFORMANCE:

WINDOWS:

ANDERSEN 100 SERIES VINYL WINDOWS

CLADDING:

MATERIAL A: BOARD & BATTEN FIBER CEMENT SIDING
HZ5 SMOOTH HARDIE PANEL VERTICAL SIDING AND HZ5 SMOOTH BATTEN
BOARDS BY JAMES HARDIE BUILDING PRODUCTS.

MATERIAL B: CORRUGATED METAL WALL PANEL 7/8" CORRUGATED METAL SIDING PANEL BY BRIDGERSTEEL. 22 OR 24 GUAGE. EXPOSED FASTENERS. PVDF OR GALVALUME FINISH.

INSULATION:

R-19 FIBERGLASS BATT INSULATION AT EXTERIOR WALLS
R-38 CLOSED CELL SPRAY FOAM INSULATION AT ROOF/CEILINGS
R-13 CLOSED CELL SPRAY FOAM INSULATION AT FLOOR

WEATHER BARRIES

VAPOR-PERMEABLE AIR BARRIER. DUPONT HOMEWRAP OR EQUIVALENT.

ROOFING

20+ SRI COMPOSITE SHINGLE, OWENS CORNING COOL ROOF SHINGLE IN HARBOR FOD OR MYSTIC GRAY.

GYPSUM WALL BOARD: 1/2" MIN AT ALL WALLS 5/8" MIN AT ALL CEILINGS

GENERAL INFORMATION

PROJECT NAME:

DOUBLE HOUSE

DESIGNED BY:

ADAM BERMAN SIOBHAN FINLAY

RICE ARCHITECTURE CONSTRUCT

PROJECT LOCATION:

DOUBLE-HOUSE IS PERMITTED AS A RESIDENTIAL MASTERPLAN IN CONFORMANCE TO THE APPLIABLE CODES AND ORDINANCES OF THE CITY OF HOUSTON AT THE TIME OF ISSUANCE. CONFORMANCE IS LIMITED TO THE BUILDING DESIGN ONLY AND EXCLUDES ANY SPECIFIC SITE-DEPENDENT INFORMATION INCLUDING BUT NOT LIMITED TO BUILDING FOUNDATION DESIGN, GEOTECHNICAL ENGINEERING, UTILITY CONNECTIONS, BUILDING SETBACKS OR SEPARATION, DEED RESTRICTIONS, ETC.

CODE / ORDINANCE REFERENCE

OCCUPANCY: R-3 SINGLE FAMILY DWELLING

CLIMATE ZONE: 2A

CONSTRUCTION TYPE: 5B

2015 INTERNATIONAL RESIDENTIAL CODE WITH HOUSTON AMMENDMENTS

2015 INTERNATIONAL ENERGY CONSERVATION CODE WITH HOUSTON AMMENDMENTS

HOUSTON ORDINANCE 42-186

REQUIRES 2 OFF-STREET PARKING SPACES FOR A SINGLE FAMILY DWELLING AND 1 ADDITIONAL, NON-TANDEM PARKING SPACE FOR A SECONDARY DWELLING.

AREAS

BUILDING AREA (GROSS): 571 SF INTERIOR AREA (NET): 506 SF EXTERIOR PORCH AREA WITH STAIRS: 233 SF TOTAL BUILT COVERAGE AREA WITHOUT PLANTER: 805 SF

ACKNOWLEDGMENT & DISCLAIMER

THE DOUBLE-HOUSE DESIGN ("THE PROJECT") IS THE WINNING COMPETITION ENTRY FROM THE CITY OF HOUSTON'S 2021 ADUJHOU DESIGN COMPETITION. THE PROJECT WAS DESIGNED BY STUDENTS SIOBHAN FINLEY AND ADAM BERMAN AS PART OF THE RICE ARCHITECTURE CONSTRUCT PROGRAM AT RICE UNIVERSITY. COPYRIGHT OF THE DESIGN AND INSTRUMENTS OF SERVICE SHALL BE RETAINED BY RICE UNIVERSITY ("RICE"), SIOBHAN FINLEY AND ADAM BERMAN (THE "DESIGNERS").

RICE AND THE DESIGNERS GRANT THE CITY OF HOUSTON ("THE CITY") A WORLDWIDE, PERPETUAL, ROYALTY-FREE, NON-EXCLUSIVE RIGHT TO USE, COPY, DISTRIBUTE, TRANSLATE, MODIFY, DISPLAY, AND PREPARE DERIVATIVE WORKS OF THE PROJECT FOR ANY PURPOSE, INCLUDING, BUT NOT LIMITED TO, DEVELOPMENT OF CONSTRUCTION DOCUMENTS, CONSTRUCTION, PUBLICATION, AND EXHIBITION OF THE PROJECT. IN SO DOING, THE CITY AGREES TO INDEMNIFY AND HERBY FOREVER RELEASES RICE AND THE DESIGNERS FROM ALL LIABILITIES THAT MIGHT ARISE FROM THE USE OF THESE DOCUMENTS, INCLUDING BUT NOT LIMITED TO THEIR USE AS INSTRUMENTS OF SERVICE FOR THE PERMITTING OR CONSTRUCTION OF THE PROJECT.

RICE AND THE DESIGNERS FREELY GRANT ANY INDIVIDUAL OR NON-PROFIT ORGANIZATION A NON-EXCLUSIVE RIGHT TO MAKE USE OF THESE DOCUMENTS, TO COPY AND MODIFY AS-NEEDED, IN ORDER TO CONSTRUCT THE PROJECT. IN DOING SO, SAID INDIVIDUAL OR NON-PROFIT ORGANIZATION AGREES TO INDEMNIFY AND HERBY FOREVER RELEASES RICE AND THE DESIGNERS FROM ALL LIABILITIES THAT MIGHT ARISE FROM THE USE OF THESE DOCUMENTS, INCLUDING BUT NOT LIMITED TO THEIR USE AS INSTRUMENTS OF SERVICE FOR THE PERMITTING OR CONSTRUCTION OF THE PROJECT.

THE USE OF THESE DOCUMENTS BY FOR-PROFIT COMPANIES OR BY INDIVIDUALS FOR-PROFIT IS PROHIBITED.

<u>DESIGNED BY:</u> SIOBHAN FINLAY ADAM BERMAN

RICE ARCHITECTURE CONSTRUCT

DISCLAIMER: THESE DOCUMENTS ARE MADE FREELY AVAILABLE TO THE CITY OF HOUSTON, INDIVIDUALS AND NON-PROFITS FOR PERMITTING AND CONSTRUCTION WITH THE AGREEMENT TO INDEMNIFY AND FOREVER RELEASE RICE AND THE DESIGNERS FROM ANY LIABILITY RELATED TO THEIR USE. INCLUDING BUT NOT LIMITED TO, AS INSTRUMENTS OF SERVICE FOR PERMITTING OR CONSTRUCTION OF THE PROJECT.

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PROHIBITED.

FOR THE FULL TERMS, SEE ADDITIONAL PROJECT INFORMATION ON SHEET G0.01.

ISSUES AND REVISIONS

ISSUE DATE 5/5/2022

DOUBLE-HOUSE

SCALE NTS

SHEET CONTENTS

PROJECT INFORMATION


SHEET NUMBER

G0.01

ABBREVIATIONS

" " &	INCH (INCHES) FOOT (FEET) NUMBER AND	MATL MAX MECH MEMB	MEMBRANE
ADDL ADJ	ADDITIONAL ADJACENT	MEZZ MDF	MEZZANINE MEDIUM DENSITY FIBERBOARD
ABV A.F.F.	ABOVE ABOVE FINISHED FLOOR	MFR MID	MANUFACTURE(R) MIDDLE
_T _UM	ALTERNATE ALUMINUM	MIN MISC	MINIMUM MISCELLANEOUS
NOD	ANODIZED APPROXIMATE ARCHITECT(URAL)	MK MTL MTL PNL	ARCHITECTURAL MILLWORK METAL
G F.F.	AVERAGE BELOW FINISHED FLOOR	N N.I.C.	NORTH NOT IN CONTRACT
B	BOARD BOARD & BATTEN	NO NOM	NUMBER NOMINAL
	BUILDING LINE	NTS	NOT TO SCALE
V	BUILDING BELOW BEAM	OC OD	ON CENTER OUTSIDE DIAMETER
)	BOTTOM OF	OF	OUTSIDE FACE
O. O.I.C.	BY OWNER BOUGHT BY OWNER,	OPNG OPP	OPENING OPPOSITE
M	INSTALLED BY CONTRACTOR BOTTOM	OH ORD	OPPOSITE HAND OVERFLOW ROOF DRAIN
G T	BRIDGING BASEMENT	OVRHD	OVERHEAD
WN	BETWEEN	PEN PERF	PENETRATION PERFORATED
BNT	CHANNEL CABINET	PERP PL	PERPENDICULAR PLATE
NTL P.	CANTILEVER CAST IN PLACE	P.L. P LAM	PROPERTY LINE PLASTIC LAMINATED
D	CENTER LINE	PLY	PLYWOOD PANEL
	CONTROL JOINT	PT PTD	POINT / PRESSURE TREATED PAINTED
.G	CEILING	QTY	
U	CONCRETE MASONRY UNIT	QII	QUANTITY
)L (COLS)	CONTROL JOINT CLOSET CEILING CEILING HEIGHT CONCRETE MASONRY UNIT CITY OF HOUSTON COLUMN(S) COORDINATE	R, RAD RCP	REFLECTED CEILING PLAN
NC NC	COLUMN(S) COORDINATE CONCRETE CONSTRUCTION CONTINUOUS CORRUGATED	REF	ROOF DRAIN REFERENCE REMOVE
ONST ONT	CONSTRUCTION CONTINUOUS	REM REINF	REINFORCING
ORR RZ	CORRUGATED CRITICAL ROOT ZONE	I VL V	REVISION
TR J FT	CENTER CUBIC FEET	RF RFG	ROOF ROOFING
IN YD	CRITICAL ROOT ZONE CENTER CUBIC FEET CUBIC INCH CUBIC YARD	RND RO	
RI	DEPTH DOUBLE DEGREE(S)	S	SOUTH SCHEDULE SMOKE DETECTOR
EG	DEGREE(S)	SD	SMOKE DETECTOR
AIG	DIAMETER DIAGONAL	SECT SF	SQUARE FEET
M FF	DIAGONAL DIMENSION DIFFUSER DOWN	SHT'G	SHEET SHEATHING SIMILAR
2	DOOR	SIM	SKETCH
VG	DRAWING	SPEC(S) S.M.D.	SIMILAR SKETCH SPECIFICATION(S) SEE MECHANICAL DRAWINGS SEE STRUCTURAL DRAWINGS SQUARE FEET SQUARE INCH STAINLESS STEEL
	EAST EACH EACH FACE EXPASION JOINT ELEVATION ELECTRICAL EMBEDDED ENGINEER(ING) EDGE OF SLAB EQUAL EQUIVALENT ET CETERA EXISTING	S.S.D. SQ FT	SEE STRUCTURAL DRAWINGS SQUARE FEET
	EACH FACE EXPASION JOINT	SQ IN SS	SQUARE INCH STAINLESS STEEL
ELEV C	ELEVATION ELECTRICAL	STD	STANDARD
BED GR	EMBEDDED ENGINEER(ING)	STRUCT SYM	STRUCTURE (STRUCTURAL) SYMMETRICAL
.S.	EDGE OF SLAB		
UIV	EQUIVALENT	T T&B T&G	TOP AND BOTTOM TOUNGE AND GROOVE
_ '	EXIOTITO	TAN	TANGENT
Γ	EXTERIOR	TBD TEMP	TEMPERATURE
N	FLOOR DRAIN FOUNDATION	THK T.O	THICK(NESS) TOP OF
F.E.	FINISH FLOOR FINISH FLOOR ELEVATION	T.O. CONC T.O.FF	TOP OF FINISH FLOOR
3. N	FINISH GRADE FINISH	T.O.S. T.O.STL T.O.T.S.	TOP OF SLAB TOP OF STEEL
	FLOOR FACE OF	TR	TREAD
O.C. O.F.	FACE OF CONCRETE FACE OF FINISH	TYP	TYPICAL
D.S. D.W.	FACE OF FINISH FACE OF STUD FACE OF WALL FIREPROOFING	U.N.O.	UNLESS OTHERWISE NOTED
P'G R.	FIREPROOFING FIRE RATED	V, VERT VB	VERTICAL VYNIL BASE
RMG	FRAMING	VCT	VYNIL COMPOSITE TILE VENTILATION
T TG	FINISH SURFACE FEET (FOOT) FOOTING	VENT VNR VIF	VENEER VERIFY IN FIELD
JR	FURRED, FURRING	VOL	VOLUME
A ALV	GUAGE GALVANIZED	W W	WEST WIDTH, WIDE
С	GENERAL CONTRACTOR GENERAL	W/ W.C.	WITH WATER CLOSET
	GRID LINE	WD	WOOD
	GRADE GYSUM WALL BOARD	W.M. WP	WATERPROOFING MEMBRANE WORKPOINT
3	HOSE BIB	W/O WRB	
M ORIZ	HOLLOW METAL HORIZONTAL	WT	WEIGHT
T .P.	HEIGHT HIGH POINT	YD	YARD
AC	HEATING, VENTILATION, AIR CONDITIONING		
	INSIDE DIAMETER		
	INSIDE FACE INCH (INCHES)		
CL	INCLUDE INFORMATION		
	INSULATION INTERIOR		
SUL			
SUL T	JOIST JOINT		
SUL T	JOINT		
SUL T ST ST	JOINT ANGLE LAMINATE LOCATION		
SUL T M C	JOINT ANGLE LAMINATE LOCATION LONG LINEAR FEET		
NFO NSUL NT ST T AM OC G F .P. W	JOINT ANGLE LAMINATE LOCATION LONG		

APPENDIX OF SYMBOLS

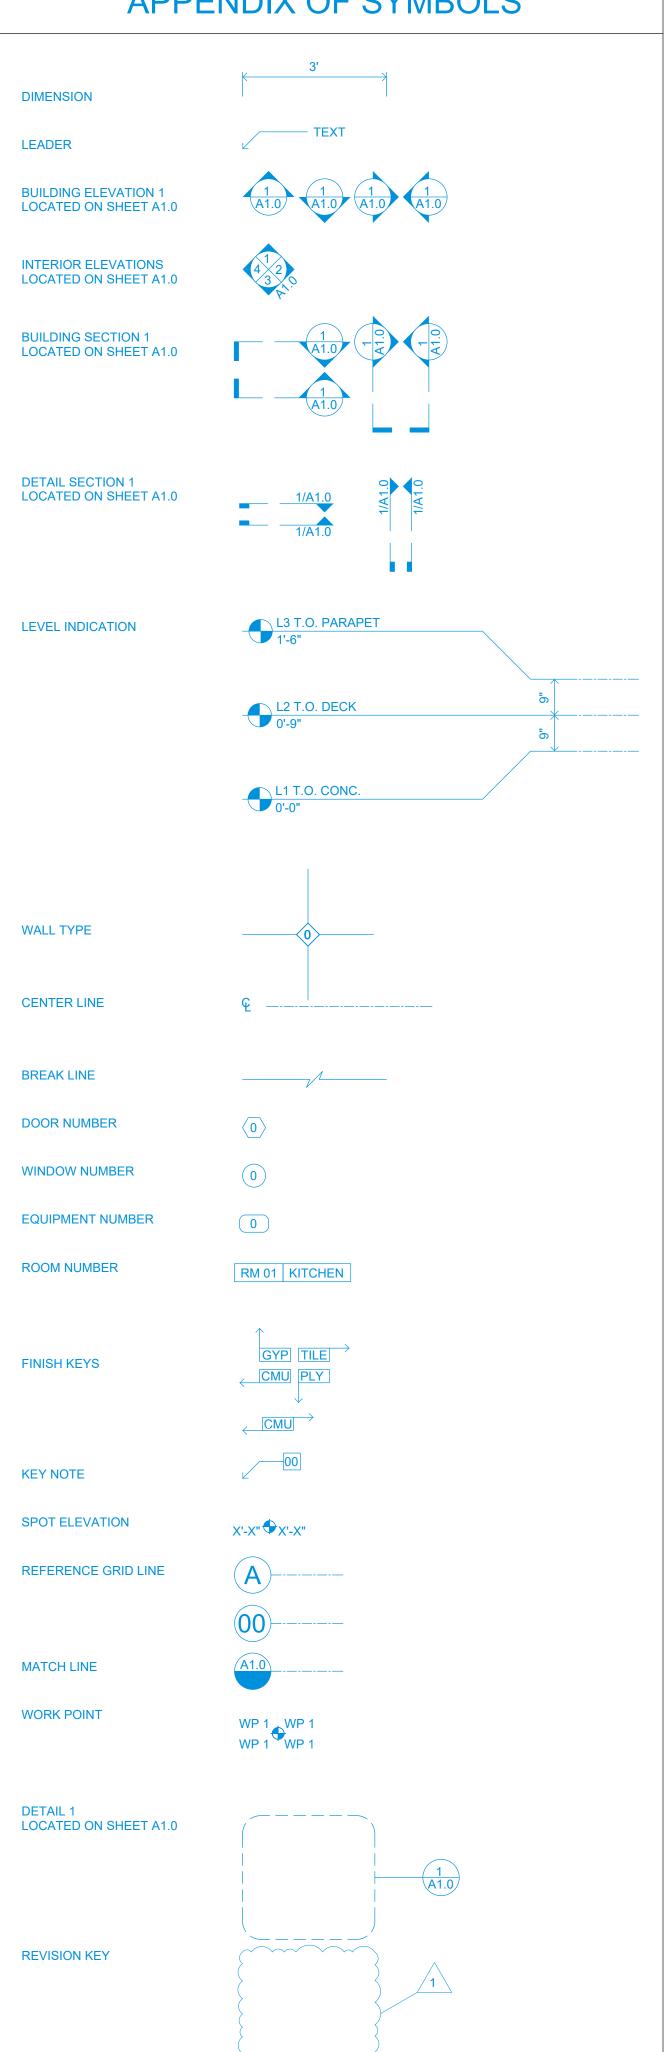

GENERAL NOTES

- 1 ALL WORK PERFORMED SHALL BE IN ACCORDANCE WITH THE APPLICABLE BUILDING CODES AND ORDINANCES OF THE CITY OF HOUSTON AND THE RULES AND REGULATIONS OF ALL AGENCIES, DEPARTMENTS AND COMMISSIONS HAVING JURISDICTION. WHERE DISCREPANCIES OCCUR AND/OR WHERE THERE ARE CONFLICTS OR OMISSIONS IN THE DRAWINGS AND APPLICATIONS, THE CONTRACTOR SHALL NOTIFY THE OWNER IMMEDIATELY AND REFRAIN FROM STARTING AND COMPLETING SUCH WORK, OR DEPENDENT WORK, UNTIL TOLD BY SAID ENTITY TO PROCEED.
- 2 THE CONTRACTOR SHALL VERIFY ALL DIMENSIONS AND EXISTING CONDITIONS IN THE FIELD PRIOR TO COMMENCING WORK AND SHALL REPORT TO THE OWNER ANY CONDITION OR DISCREPANCY BETWEEN DRAWINGS AND FIELD CONDITIONS REQUIRING MODIFICATIONS BEFORE PROCEEDING WITH THE WORK.
- MINOR DETAILS NOT USUALLY SHOWN OR SPECIFIED, BUT NECESSARY FOR PROPER CONSTRUCTION OF ANY PART OF THE WORK, SHALL BE INCLUDED AS IF THEY WERE INDICATED IN THE DRAWINGS.
- 4 REFERENCING OF DRAWINGS IS FOR CONVENIENCE ONLY AND DOES NOT LIMIT APPLICATION OF ANY DRAWING.
- 5 THE CONTRACTOR SHALL BE RESPONSIBLE FOR THE PROTECTION OF ALL CONDITIONS AND MATERIALS WITHIN THE PROPOSED CONSTRUCTION AREAS. THE CONTRACTOR SHALL MAKE USE OF ADEQUATE SHORING AND BRACING FOR ALL STRUCTURAL OR REMOVAL TASKS. THE CONTRACTOR SHALL HAVE SOLE RESPONSIBILITY FOR ANY DAMAGE OR INJURIES CAUSED BY OR DURING THE EXECUTION OF THE WORK.
- PROTECT ADJACENT EXISTING SIDEWALKS, CURBS, YARDS, LAWNS, TREES. SHRUBS, ETC. REPAIR TO THE RESPECTIVE OWNER'S SATISFACTION ALL SUCH FEATURES DAMAGED DURING THE CONSTRUCTION OPERATION.
- REFER TO STRUCTURAL DRAWINGS FOR ADDITIONAL GENERAL NOTES, ABBREVIATIONS, SYMBOLS AND LEGENDS.
- DETAILS NOT SHOWN ARE SIMILAR IN CHARACTER TO THOSE THAT ARE.
- 8 UNLESS OTHERWISE INDICATED, HEIGHTS NOTED IN SCHEDULES ARE HEIGHTS ABOVE FINISHED FLOOR.
- 9 IN GENERAL, DIMENSIONS ARE TO THE FACE OF FRAMING UNLESS OTHERWISE NOTED.
- 10 CONTRACTOR SHALL FURNISH AND INSTALL ALL LINTELS, STRUTS, BRACKETS, HANGERS, ETC. WHEREVER NECESSARY TO SUPPORT OR BRACE ALL FINISHES,
- 11 ALL EXTERIOR CORNERS AT GYPSUM WALLBOARD CONSTRUCTION SHALL HAVE METAL CORNER BEADS INSTALLED.
- 12 ALL METAL CASING BEADS AT WINDOWS AND DOORS SHALL BE OF NON-CORROSIVE TYPE.

EQUIPMENT RECESSES, HEADS OVER OPENINGS, FURNITURE, ETC.

- 13 ALL EQUIPMENT SECURED TO INTERIOR PARTITIONS SHALL BE SCREWED DIRECTLY TO STUDS.
- 14 SHOULD IT APPEAR THAT PROPOSED WORK IS NOT CLEARLY CALLED OUT, OR IS NOT SUFFICIENTLY DETAILED OR EXPLAINED ON DRAWINGS OR IN SPECIFICATIONS. OR IF CONTRACTOR HAS A BETTER CONSTRUCTION TECHNIQUE OR PROCEDURE: THE CONTRACTOR MUST APPLY TO THE OWNER FOR CLARIFICATION OR SUBMIT DRAWINGS AND PROCEDURES CONSISTENT WITH THE DESIGN INTENT FOR APPROVAL BY THE OWNER. THE ARCHITECT'S DECISION WILL BE FINAL AND CONCLUSIVE. IN NO CASE WILL WORK PROCEED IN UNCERTAINTY.
- 15 ALL SUBCONTRACTORS MUST REVIEW THE MANNER IN WHICH WORK FITS, ALIGNS, OR COMES INTO CONTACT WITH THE WORK OF OTHER TRADES. DEFICIENCIES RESULTING FROM FAILURE TO DO SO WILL BE REMOVED AND CORRECTED AT CONTRACTOR'S EXPENSE. EACH SUBCONTRACTOR IS CONSIDERED A SPECIALIST IN HIS/HER RESPECTIVE FIELD AND SHALL, PRIOR TO THE SUBMISSION OF BID OR PERFORMANCE OF HIS/HER WORK, NOTIFY THE CONTRACTOR OF ANY WORK CALLED OUT IN THESE DOCUMENTS THAT CANNOT BE EXECUTED AS SHOWN OR DESCRIBED OR CANNOT BE FULLY GAURANTEED.
- 16 IT SHALL BE THE RESPONSIBILITY OF THE CONTRACTOR TO CHECK WITH THE ARCHITECTURAL DRAWINGS BEFORE THE INSTALLATION OF THE STRUCTURAL, ELECTRICAL, PLUMBING OR MECHANICAL WORK. ANY DISCREPANCY BETWEEN THE ARCHITECTURAL AND THE CONSULTANTS' OR SUBCONTRACTOR'S WORK SHALL BE BROUGHT TO THE OWNER'S ATTENTION FOR CLARIFICATION.
- 17 ACTUAL FIELD CONDITIONS MAY VARY FROM THE PLANS. ANY DISCREPANCIES BETWEEN THE DRAWINGS AND FIELD CONDITIONS SHALL BE REPORTED IMMEDIATELY TO THE OWNER. NO DEVIATION FROM THE CONTRACT DOCUMENTS SHALL BE MADE WITHOUT WRITTEN APPROVAL FROM THE OWNER.
- 18 THE CONTRACTOR MUST CAREFULLY STUDY AND COMPARE THE CONTRACT DOCUMENTS PRIOR TO CONSTRUCTION AND MUST AT ONCE REPORT TO THE OWNER ANY ERROR, INCONSISTENCY, OR OMISSION HE/SHE MAY DISCOVER AND SHALL NOT PROCEED WITH THE WORK UNTIL THE INTENT OF THE DOCUMENTS IS VERIFIED BY THE OWNER.
- 19 THE CONTRACTOR SHALL VERIFY AND COORDINATE ALL FOUNDATION PLAN DIMENSIONS WITH THE FLOOR PLAN. THE CONTRACTOR SHALL PROVIDE, COORDINATE AND FIELD VERIFY THE DIMENSION, SIZES AND POSITIONS OF OPENINGS IN SLABS AND WALLS NECESSARY TO INSTALLATION OF HIS/HER WORK. PRIOR TO POURING CONCRETE, THE CONTRACTOR SHALL VERIFY THAT ALL EMBEDDED ITEMS AND MATERIALS, INCLUDING THE WORK OF OTHER TRADES, ARE IN PLACE AND SECURELY ANCHORED.
- 20 THE CONTRACTOR SHALL CONNECT ALL SERVICES TO PUBLIC UTILITIES. ALL UTILITIES SHALL BE CONNECTED TO PROVIDE ELECTRICITY, WATER, ETC. TO ALL EQUIPMENT SHOWN AS PART OF THIS CONTRACT. ALL EQUIPMENT SHALL FUNCTION CORRECTLY UPON COMPLETION OF THIS CONTRACT.

GENERAL NOTES (CONT.)

- 21 APPROVAL BY A BUILDING AND SAFETY INSPECTOR DOES NOT CONSTITUTE AUTHORITY TO DEVIATE FROM CONTRACT DOCUMENTS.
- 22 THE CONTRACTOR IS RESPONSIBLE FOR THE PROTECTION OF EXISTING STRUCTURES AND FINISHES DURING CONSTRUCTION.
- 23 CONTRACTOR TO VERIFY DOOR AND WINDOW SIZES, SWINGS, LOCATIONS, AND DETAILS WITH JOB CONDITIONS PRIOR TO FABRICATION AND INSTALLATION.
- 24 DRAWINGS ARE DIVIDED INTO SEPARATE SHEETS FOR GENERAL CONVENIENCE ONLY. SHEET DESIGNATION OR NUMBERS MUST NOT BE CONSIDERED A BREAKDOWN OF AREAS OF WORK RESPONSIBILITY OR TRADES. DRAWINGS MUST BE COORDINATED WITH EACH OTHER AND WITH THE PROJECT
- 25 ABBREVIATIONS THROUGHOUT THE PLANS ARE THOSE IN COMMON USE.
- 26 ALL DISSIMILAR METALS MUST BE EFFECTIVELY ISOLATED FROM EACH OTHER TO PREVENT MOLECULAR BREAKDOWN.
- 27 LUMBER ON CONCRETE OR MASONRY WHICH IS IN CONTACT WITH EARTH MUST BE PRESSURE TREATED WOOD. ALL FLOOR FRAMING MUST BE PRESSURE TREATED

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	G0.01	PROJECT INFORMATION			
	G0.02	INDEX, NOTES & DRAWING INFO			
ARCHITECTURAL	A1.00	SITE PLAN & PLANTER DETAIL			
	A1.01	FLOOR PLAN			
	A1.02	ROOF PLAN			
	A1.11	REFLECTED CEILING PLAN			
	A2.01	SECTIONS			
	A3.01	ELEVATIONS			
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STRUCTURAL	S1.00	STRUCTURAL NOTES			
	S1.01	FOUNDATION PLAN - PIER & BEAM			
	S1.02	FLOOR FRAMING PLAN - PIER & BEAM			
	S1.10	ALT CONCRETE FOUNDATION PLAN			
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	S1.12	ROOF FRAMING PLAN			
PLUMB/MECH	MP1.00	PLUMBING & MECHANICAL PLAN			
ELECTRICAL	E1.00	ELECTRICAL REFLECTED CEILING PLAN			

DESIGNED BY: SIOBHAN FINLAY ADAM BERMAN

DISCLAIMER:

CITY OF HOUSTON,

INDIVIDUALS AND

RICE ARCHITECTURE CONSTRUCT

THESE DOCUMENTS ARE MADE FREELY AVAILABLE TO THE

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AND CONSTRUCTION WITH THE

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AND THE DESIGNERS FROM

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NOT LIMITED TO, AS INSTRUMENTS OF SERVICE

FOR PERMITTING OR

USE BY FOR-PROFIT

COMPANIES OR BY

PROJECT.

PROHIBITED.

CONSTRUCTION OF THE

INDIVIDUALS FOR-PROFIT IS

FOR THE FULL TERMS, SEE ADDITIONAL PROJECT

ISSUES AND REVISIONS

ISSUE DATE 5/5/2022

INFORMATION ON SHEET G0.01.

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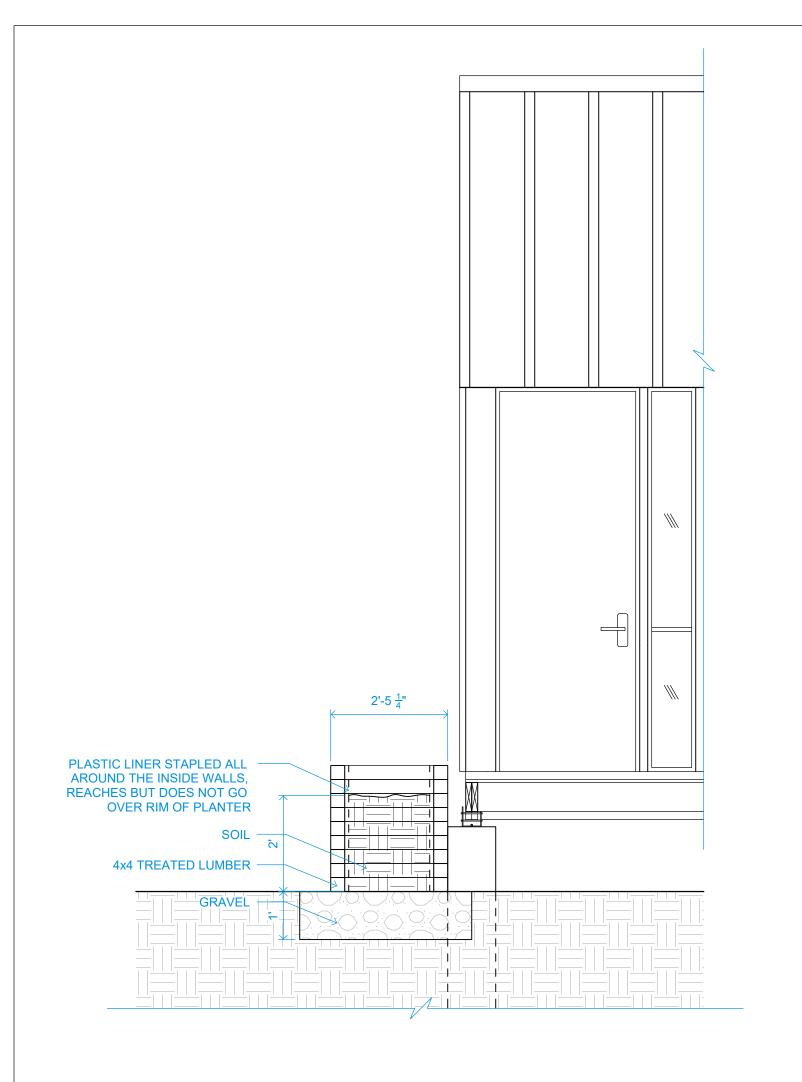
DOUBLE-HOUSE

SCALE NTS


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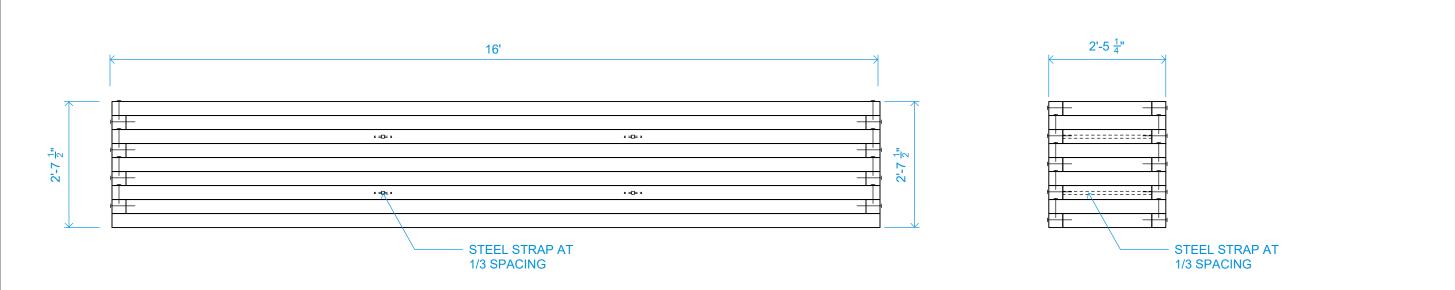
SHEET NUMBER



6 PLANTER SECTION 1/2" = 1'-0"



5 PLANTER PLAN 1/2" = 1'-0"

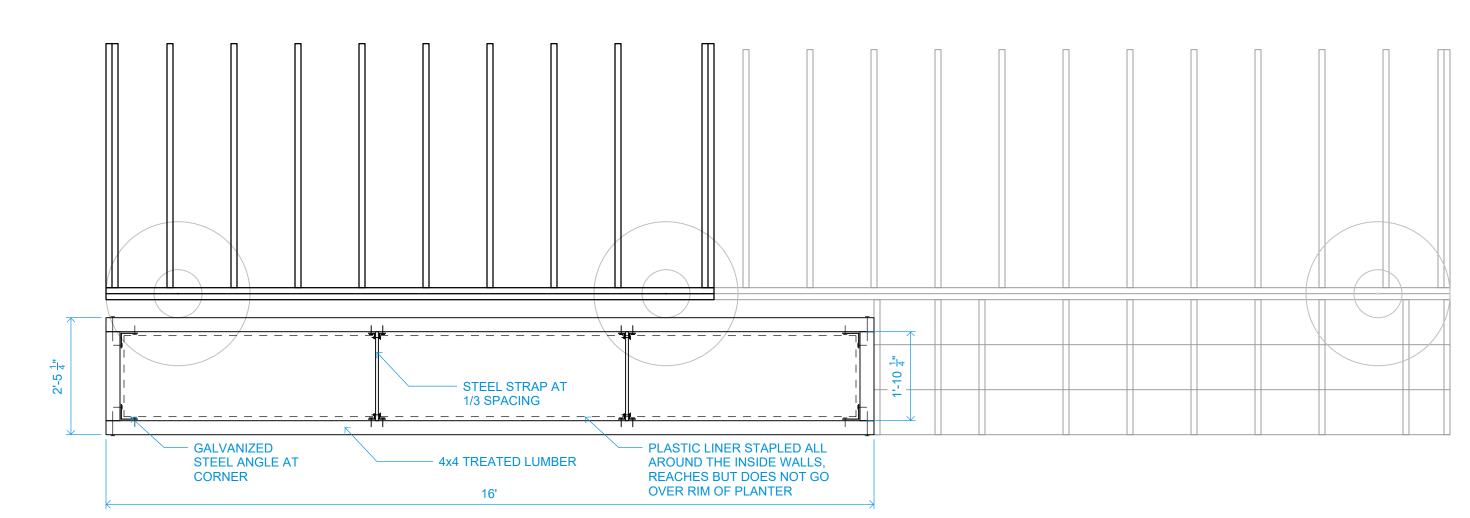



POSSIBLE RAMP CONFIGURATIONS SHOWN FOR INFORMATIONAL PURPOSE ONLY. RAMPS ARE NOT INCLUDED AS PART OF THIS PERMIT SET.

RELATIVE GRADE DIFFERENCE FROM PORCH ELEVATION. RAMPS INDICATED ASSUME A DIFFERENCE OF 2' - 4'

SUME A DIFFERENCE OF 2' - 4'

HANDRAILS SHOULD BE PROVIDED IN ACCORDANCE TO IRC 2015 R31.7.8

PER IRC R311.8:

R311.8.1 Maximum Slope

Ramps serving the egress door required by Section R311.2 shall have a slope of not more than 1 unit vertical in 12 units horizontal (8.3-percent slope). Other ramps shall have a maximum slope of 1 unit vertical in 8 units horizontal (12.5 percent).

Exception: Where it is technically infeasible to comply because of site constraints, ramps shall have a slope of not more than 1 unit vertical in 8 units horizontal (12.5 percent).

R311.8.2 Landings Required

There shall be a floor or landing at the top and bottom of each ramp, where doors open onto ramps, and where ramps change directions. The width of the landing perpendicular to the ramp slope shall be not less than 36 inches (914 mm).

R311.8.3 Handrails Required

Handrails shall be provided on not less than one side of ramps exceeding a slope of one unit vertical in 12 units horizontal (8.33-percent slope).

SITE GENERAL NOTES

LOCATE THE SECONDARY DWELLING AT THE END OF A DRIVEWAY (IF EXIST) TO ENSURE EASE OF ACCESS AND STREET VISIBILITY.

THE BUILDING CODE REQUIRES A MINIMUM 5FT SETBACK FROM THE PROPOERTY LINE AND 10FT FROM EXISTING BUILDINGS.

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<u>DESIGNED BY:</u> SIOBHAN FINLAY ADAM BERMAN

CONSTRUCT

DISCLAIMER:


RICE ARCHITECTURE

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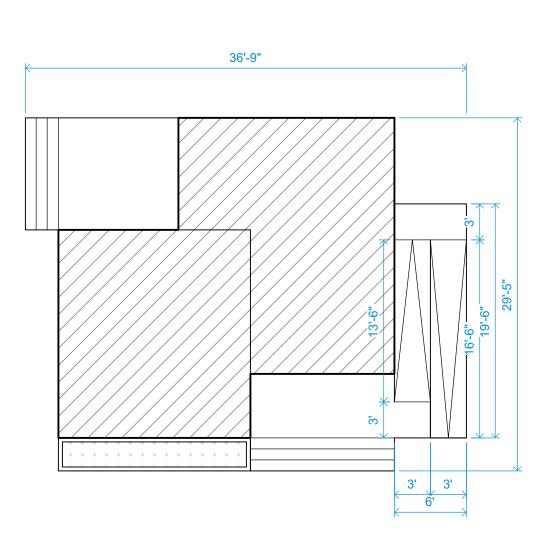
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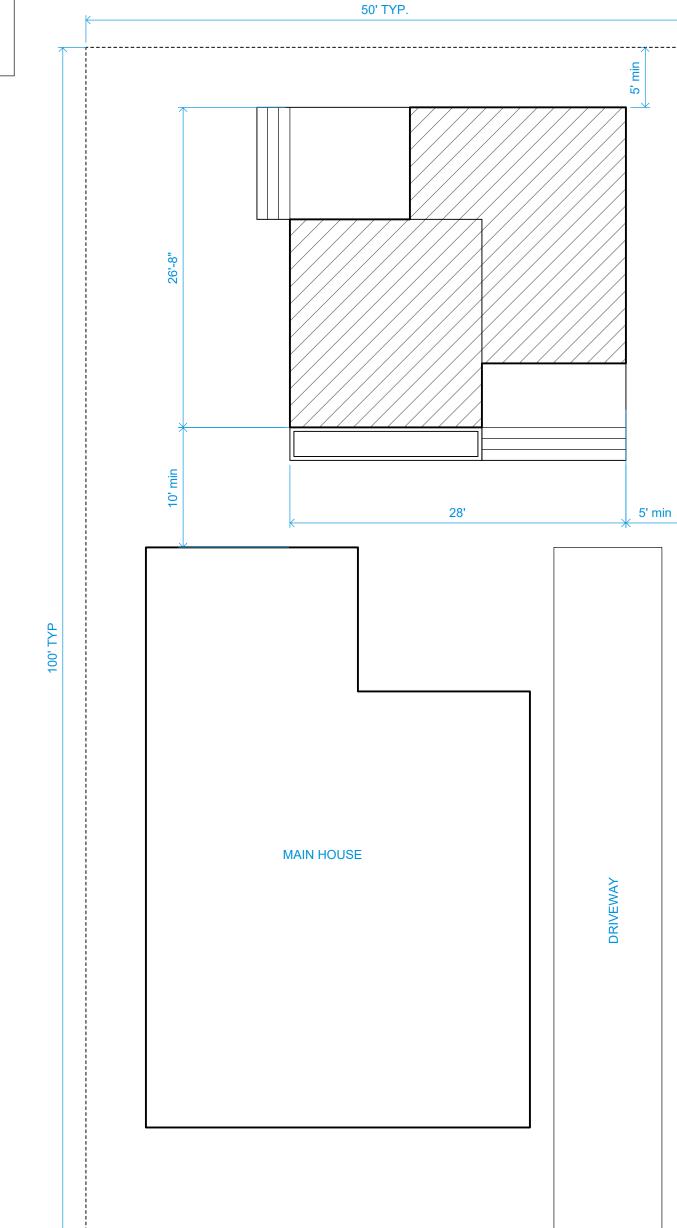
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33'-9"





DOUBLE-HOUSE

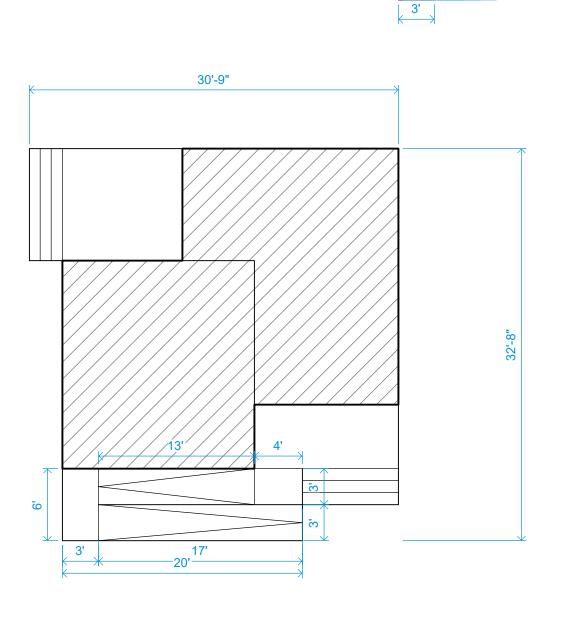SCALE 1/8" = 1' - 0"

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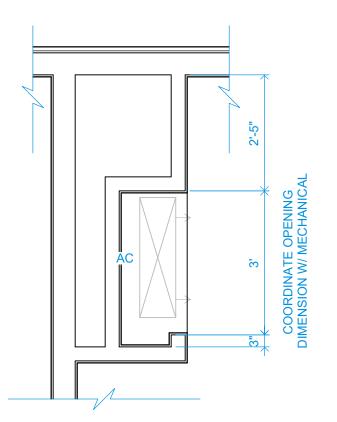
SITE PLAN & PLANTER DETAILS

SHEET NUMBER

3 PLANTER SIDE ELEVATION 1/2" = 1'-0"


2 RAMP OPTIONS

1 SITING PLAN FOR TYPICAL LOT CONFIGURATION 1/8" = 1'-0"




MECHANICAL ALCOVE ABOVE CLOSET

1/2" = 1'-0"

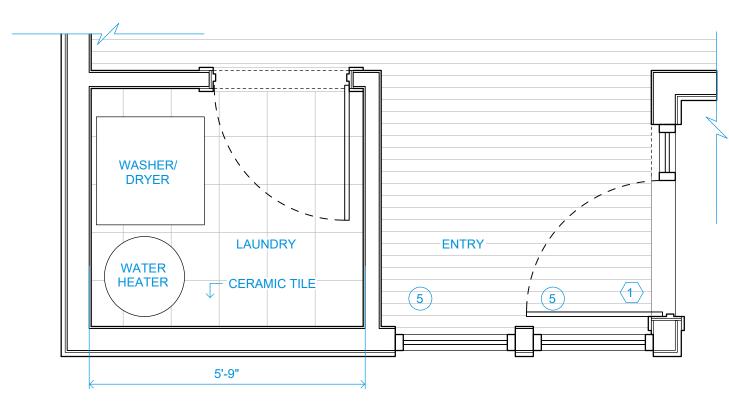


4 ALTERNATIVE 3: LAUNDRY ROOM 1/2" = 1'-0"

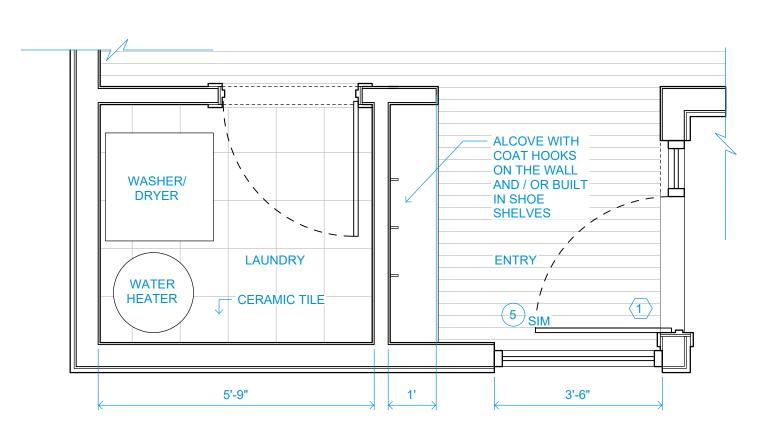


3 ALTERNATIVE 2: LAUNDRY ROOM + ALCOVE

1/2" = 1'-0"

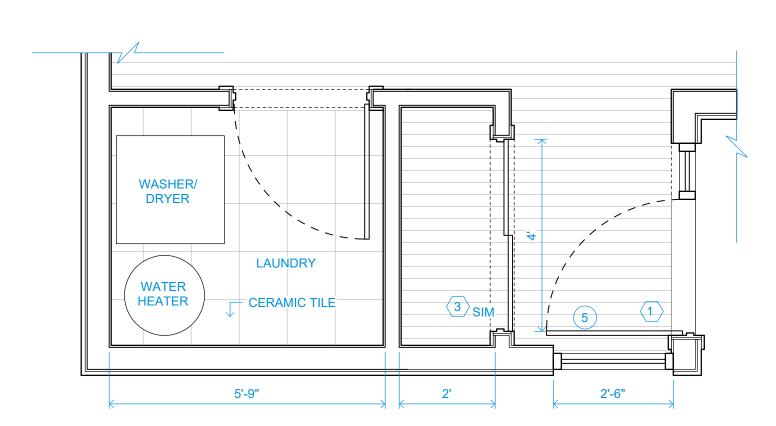

2 ALTERNATIVE 1: LAUNDRY ROOM + COAT CLOSET

1/2" = 1'-0"

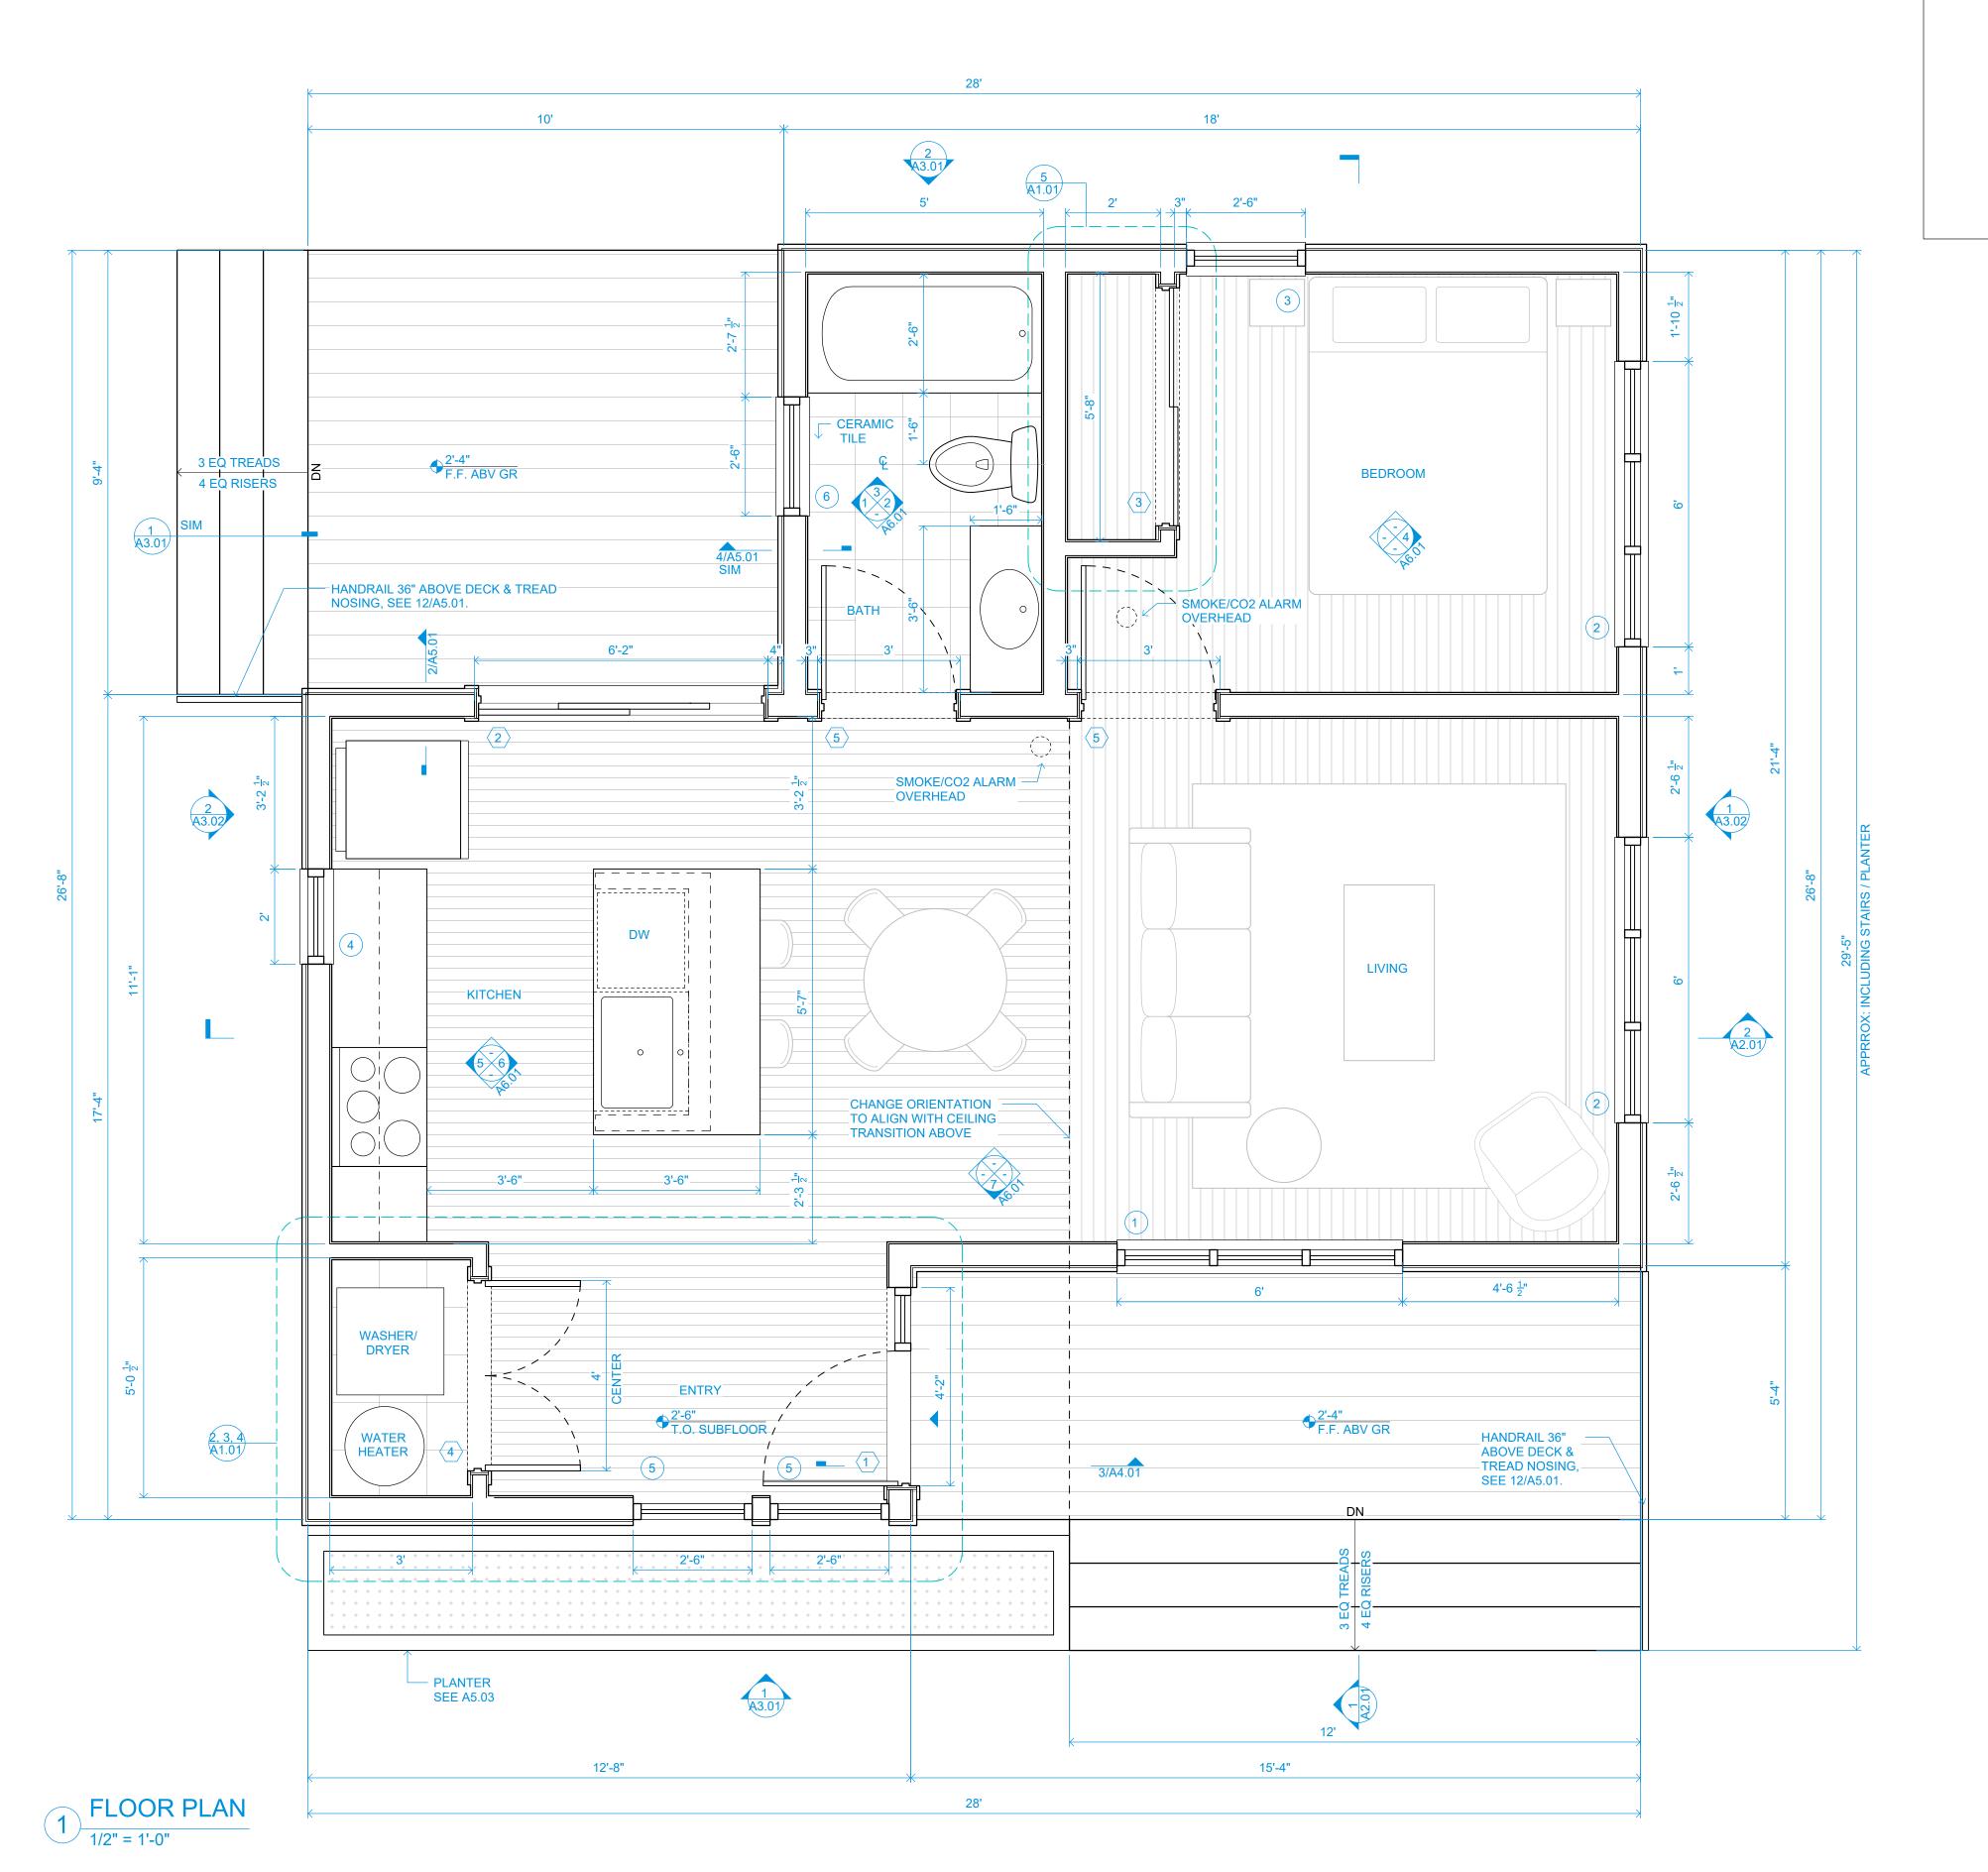

GENERAL NOTES

REFER TO A1.00 SITE PLANS FOR ACCESSIBLE RAMP LAYOUT OPTIONS.

DIMENSIONS INDICATED ARE TO FACE OF FRAMING U.N.O.

SEE ALTERNATIVE OPTIONS FOR LAUNDRY ROOM LAYOUTS.

ENSURE PROPER COORDINATION

OPENING.

BETWEEN SELECTED WINDOW/DOOR

MANUFACTURER AND REQUIRED ROUGH

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RICE ARCHITECTURE CONSTRUCT

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PROJECT.

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ISSUES AND REVISIONS

ISSUE DATE 5/5/2022

DOUBLE-HOUSE


SCALE 1/2" = 1' - 0"

FLOOR PLAN

SHEET CONTENTS

SHEET NUMBER

A1.01

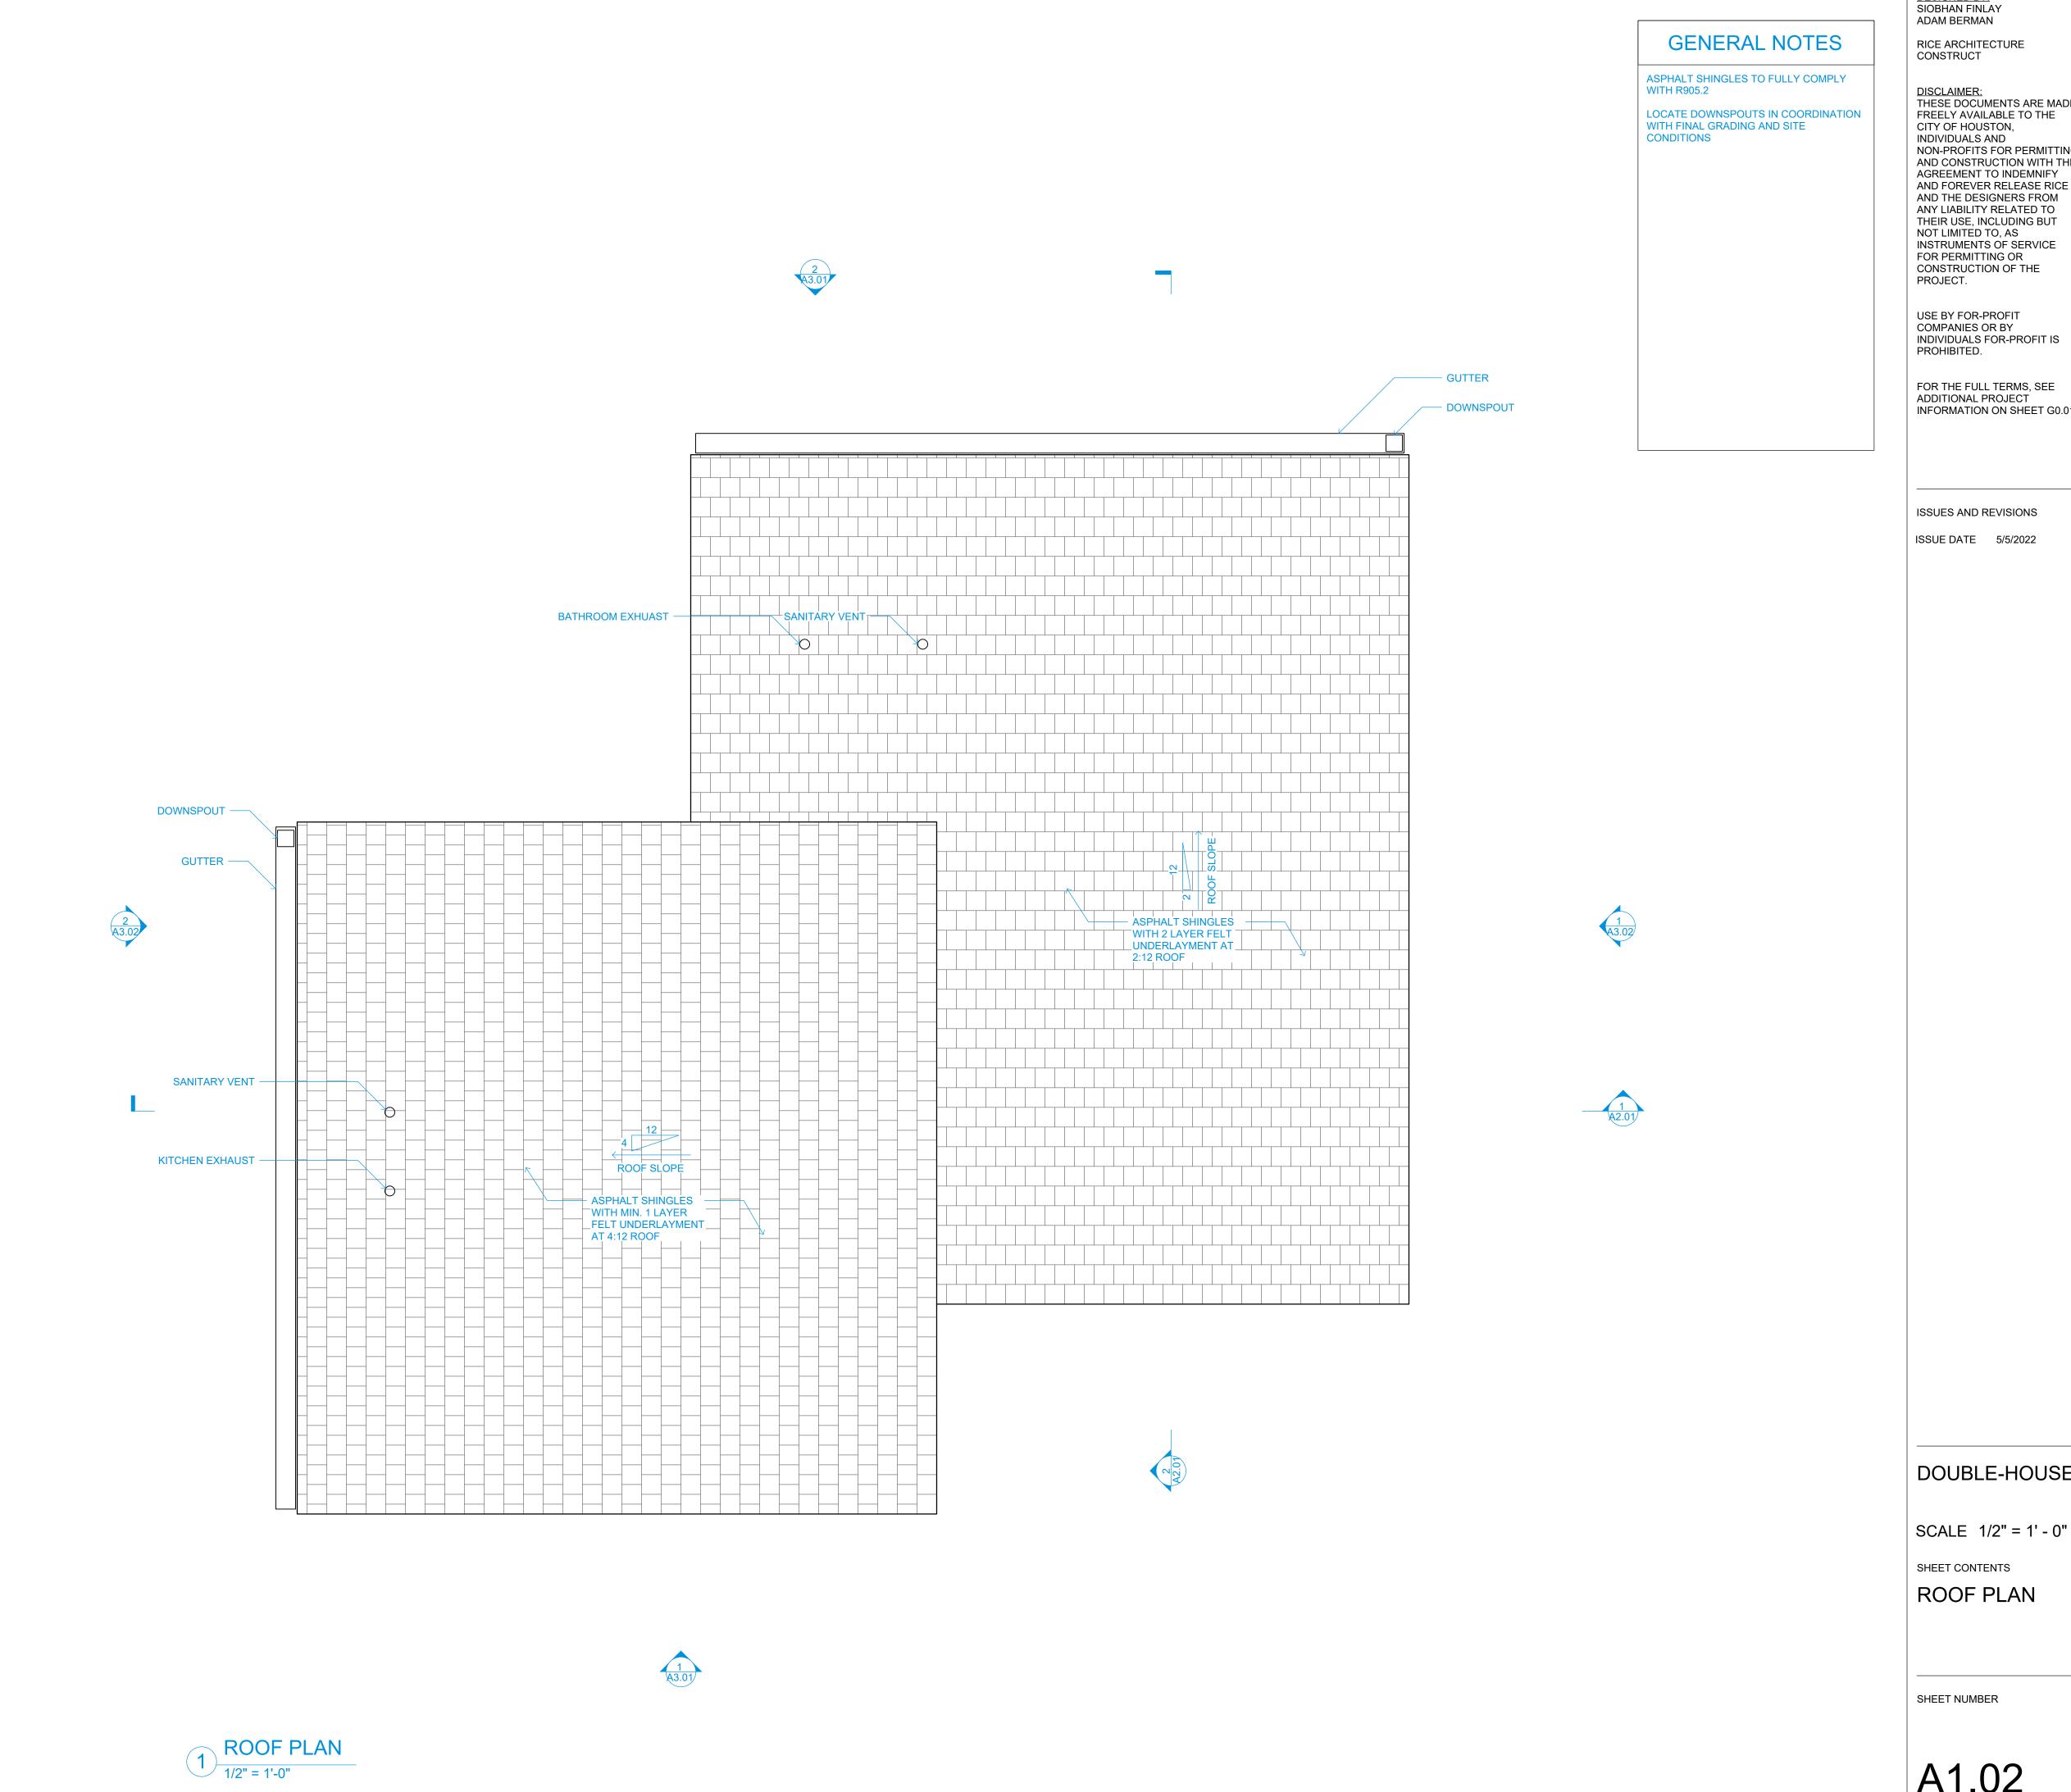

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A1.02


SHEET NUMBER

DOUBLE-HOUSE

SCALE 1/2" = 1' - 0"

SHEET CONTENTS

ROOF PLAN

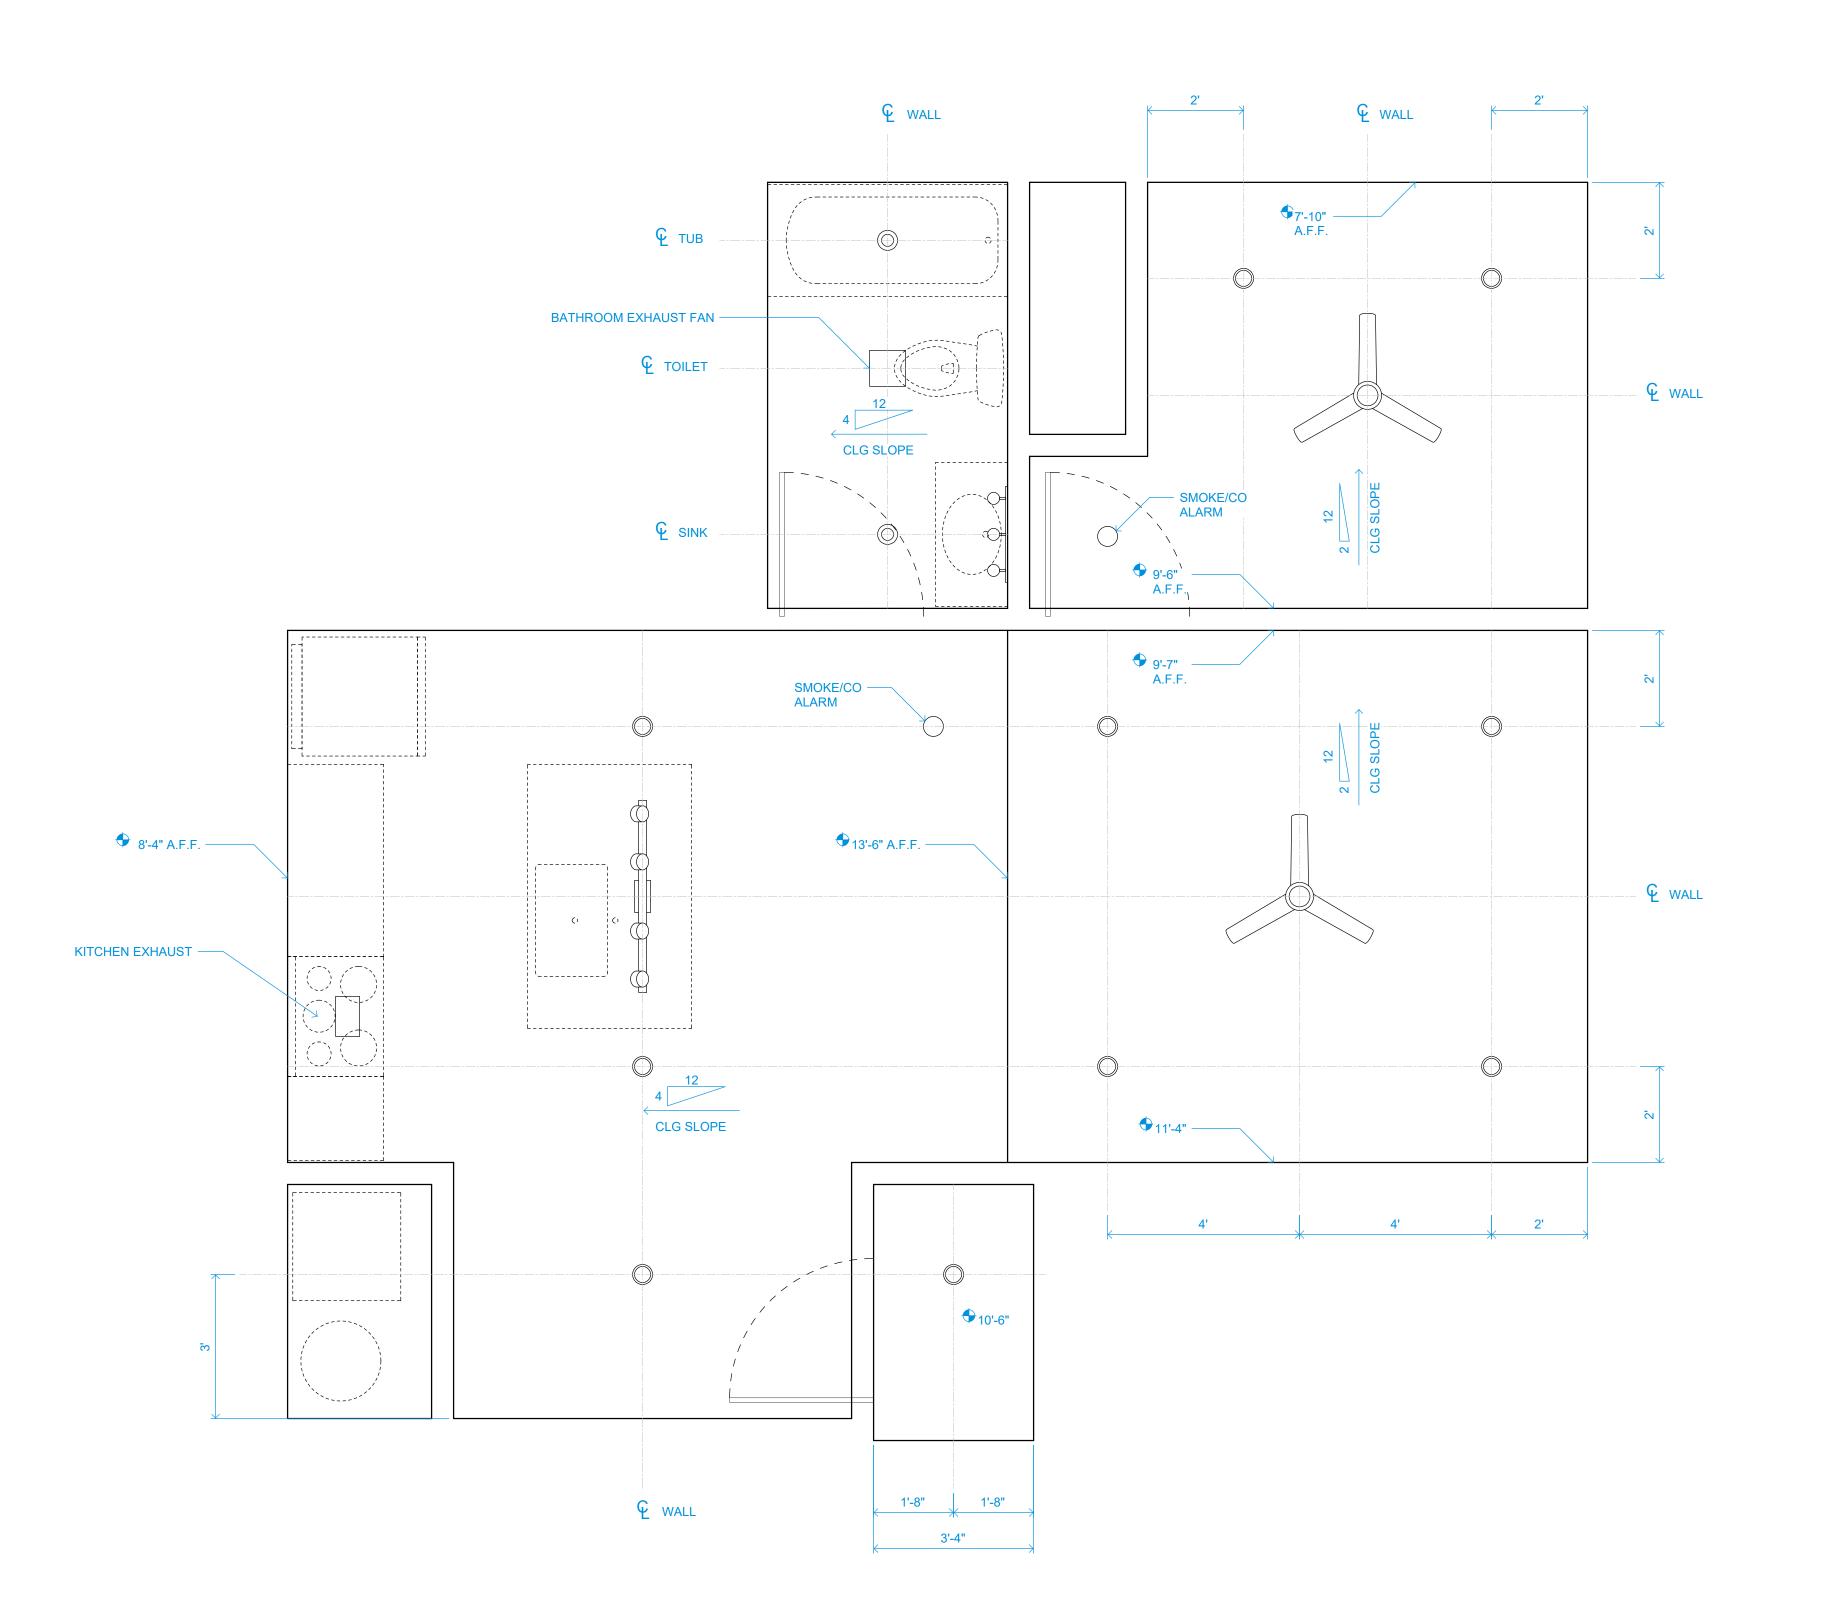

GENERAL NOTES

SEE ELECTRICAL PLAN FOR FIXTURE INFORMATION

CEILING HEIGHTS INDICATED WITH ELEVATION MARKERS ARE APPROXIMATE

DIMENSIONAL LOCATION OF FIXTURES INDICATED IN PLAN AT FLOOR LEVEL (NOT ALONG SLOPED CEILINGS)

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SCALE 1/2" = 1' - 0"


SHEET CONTENTS

REFLECTED CEILING PLAN

SHEET NUMBER

1 REFLECTED CEILING PLAN
1/2" = 1'-0"

A1.11

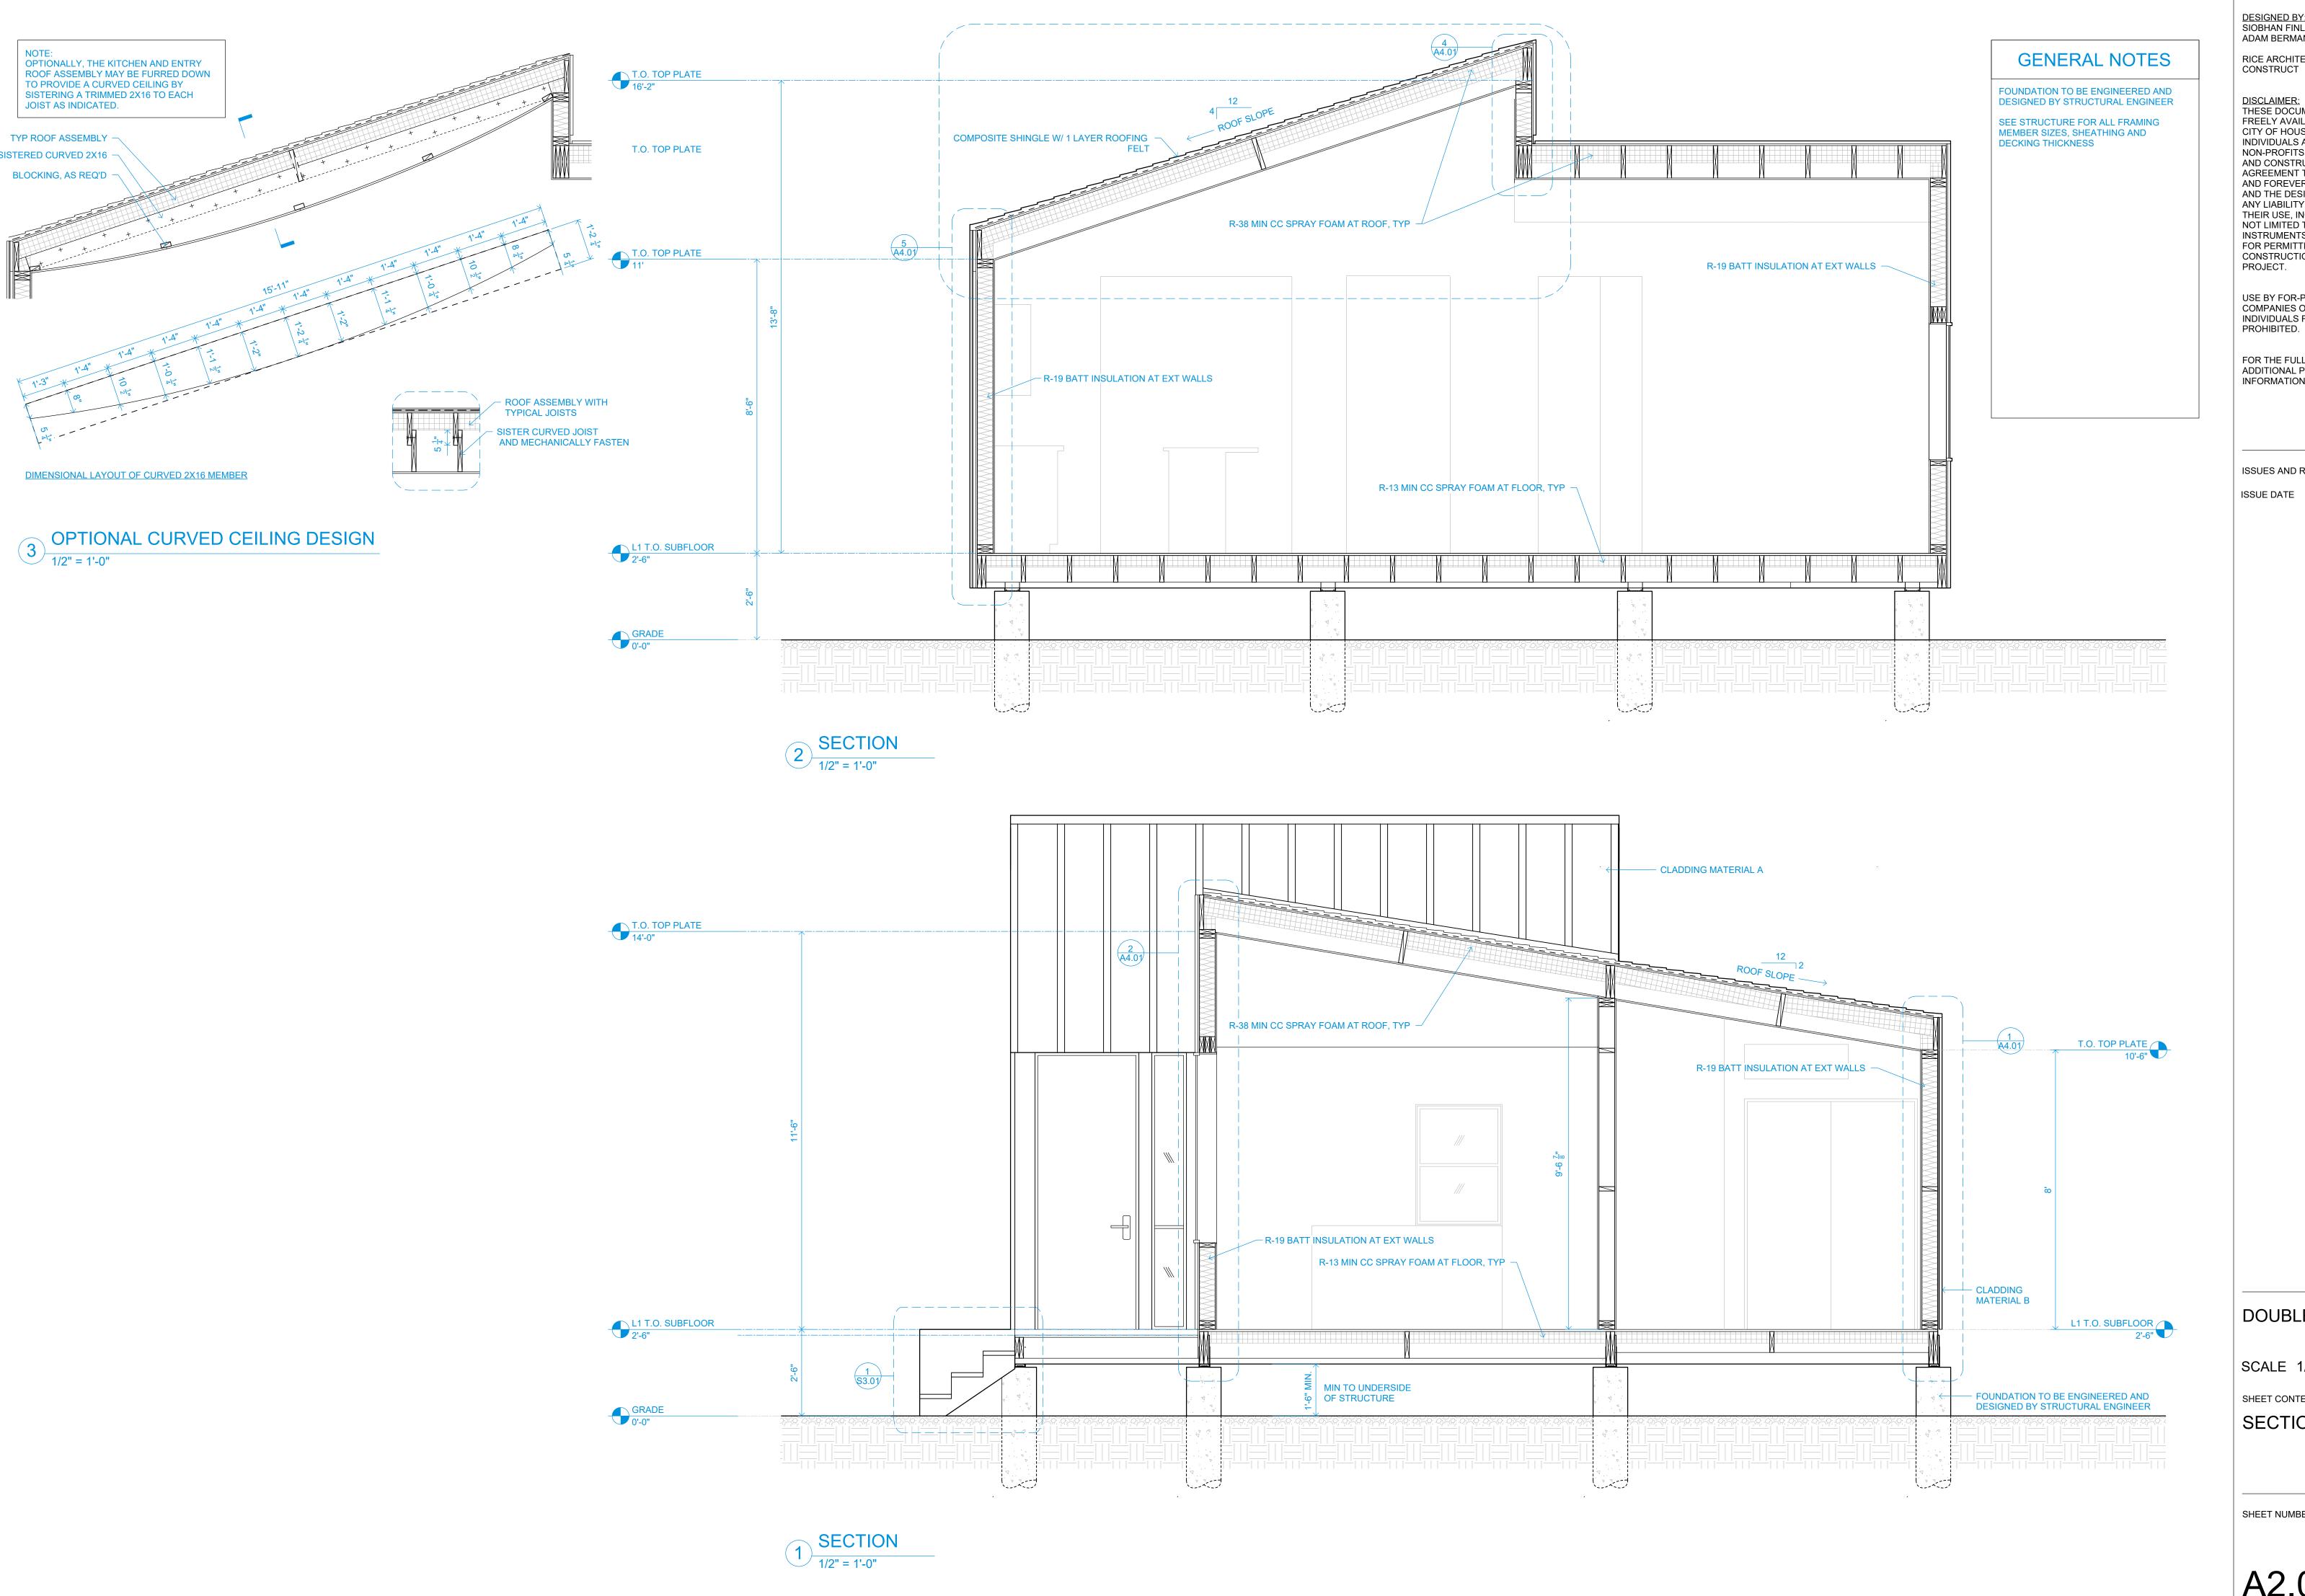

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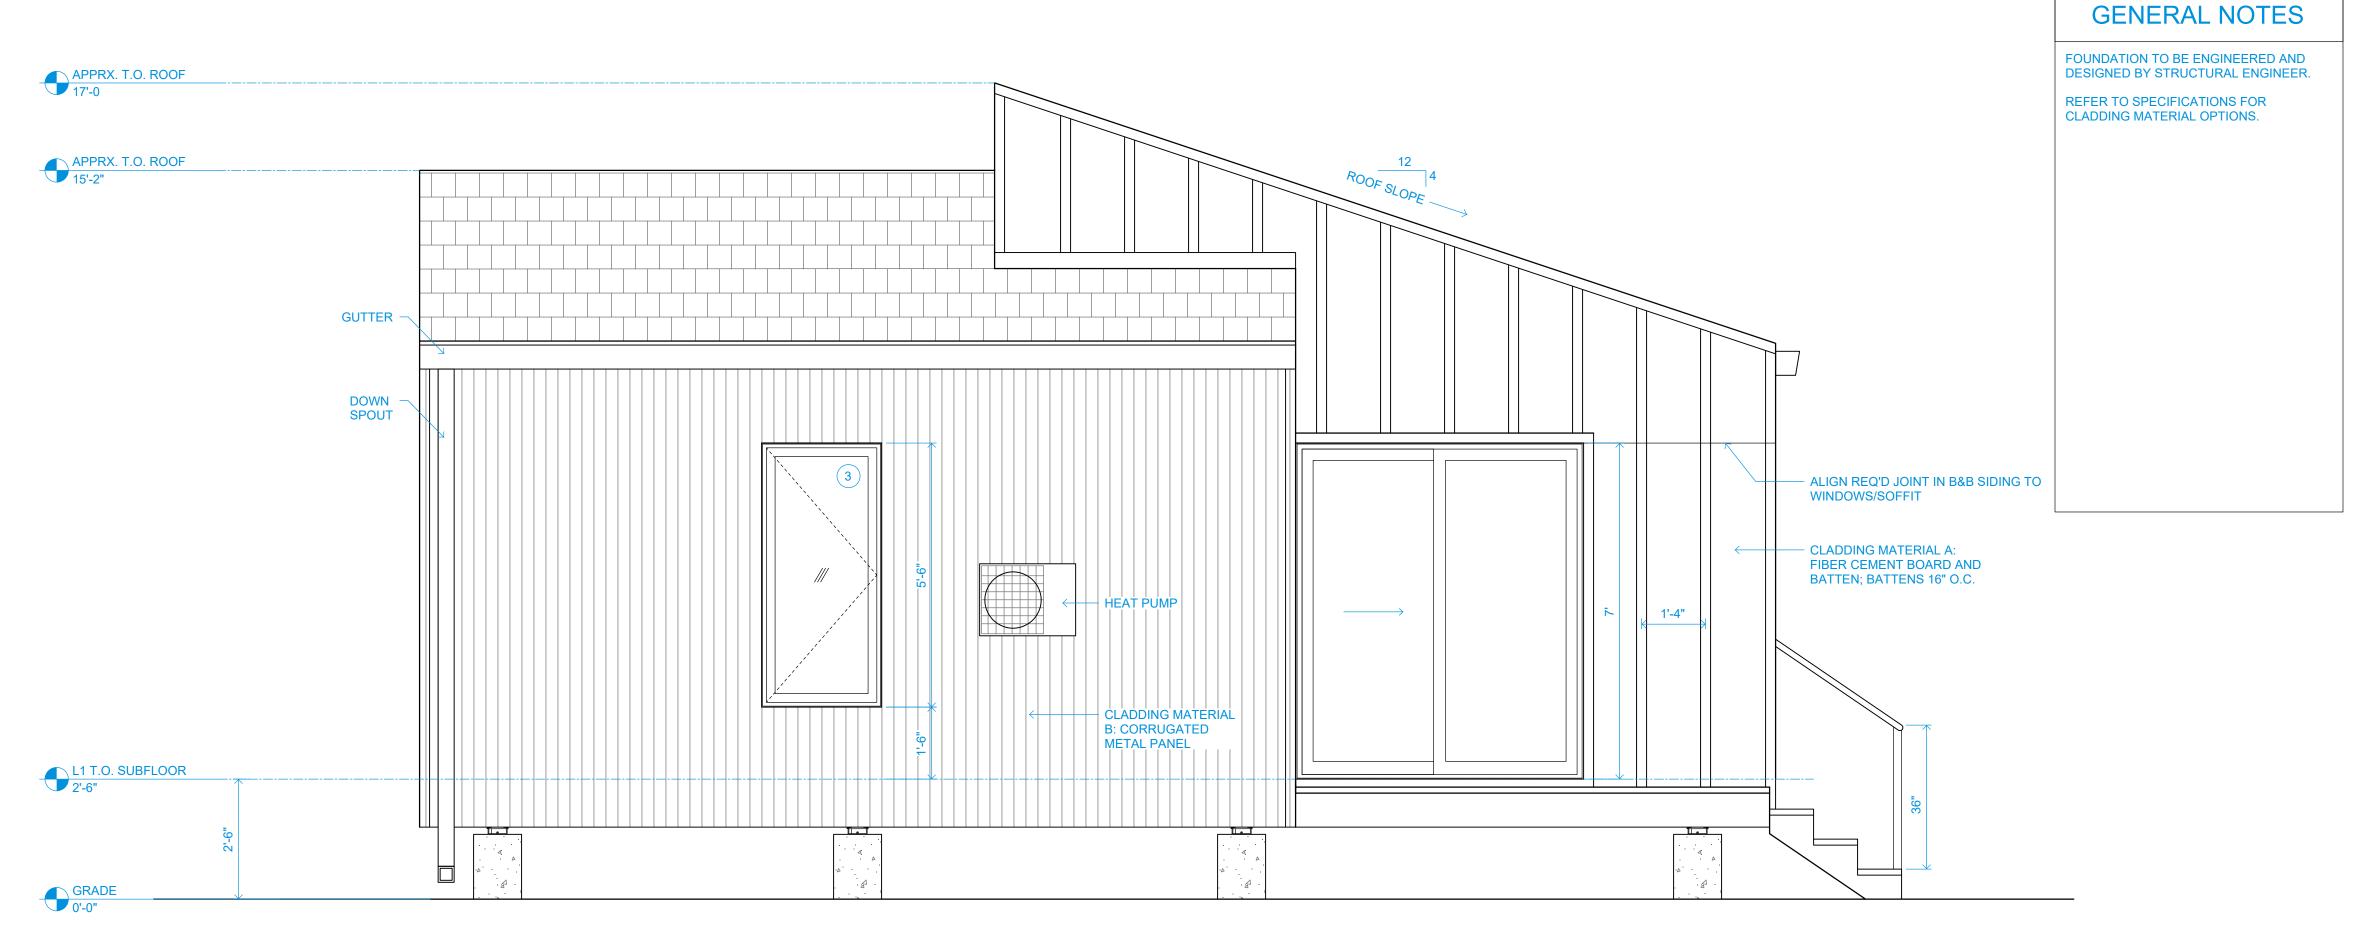
DOUBLE-HOUSE

SCALE 1/2" = 1' - 0"

SHEET CONTENTS


SECTIONS

SHEET NUMBER



2 BACK ELEVATION

1/2" = 1'-0"

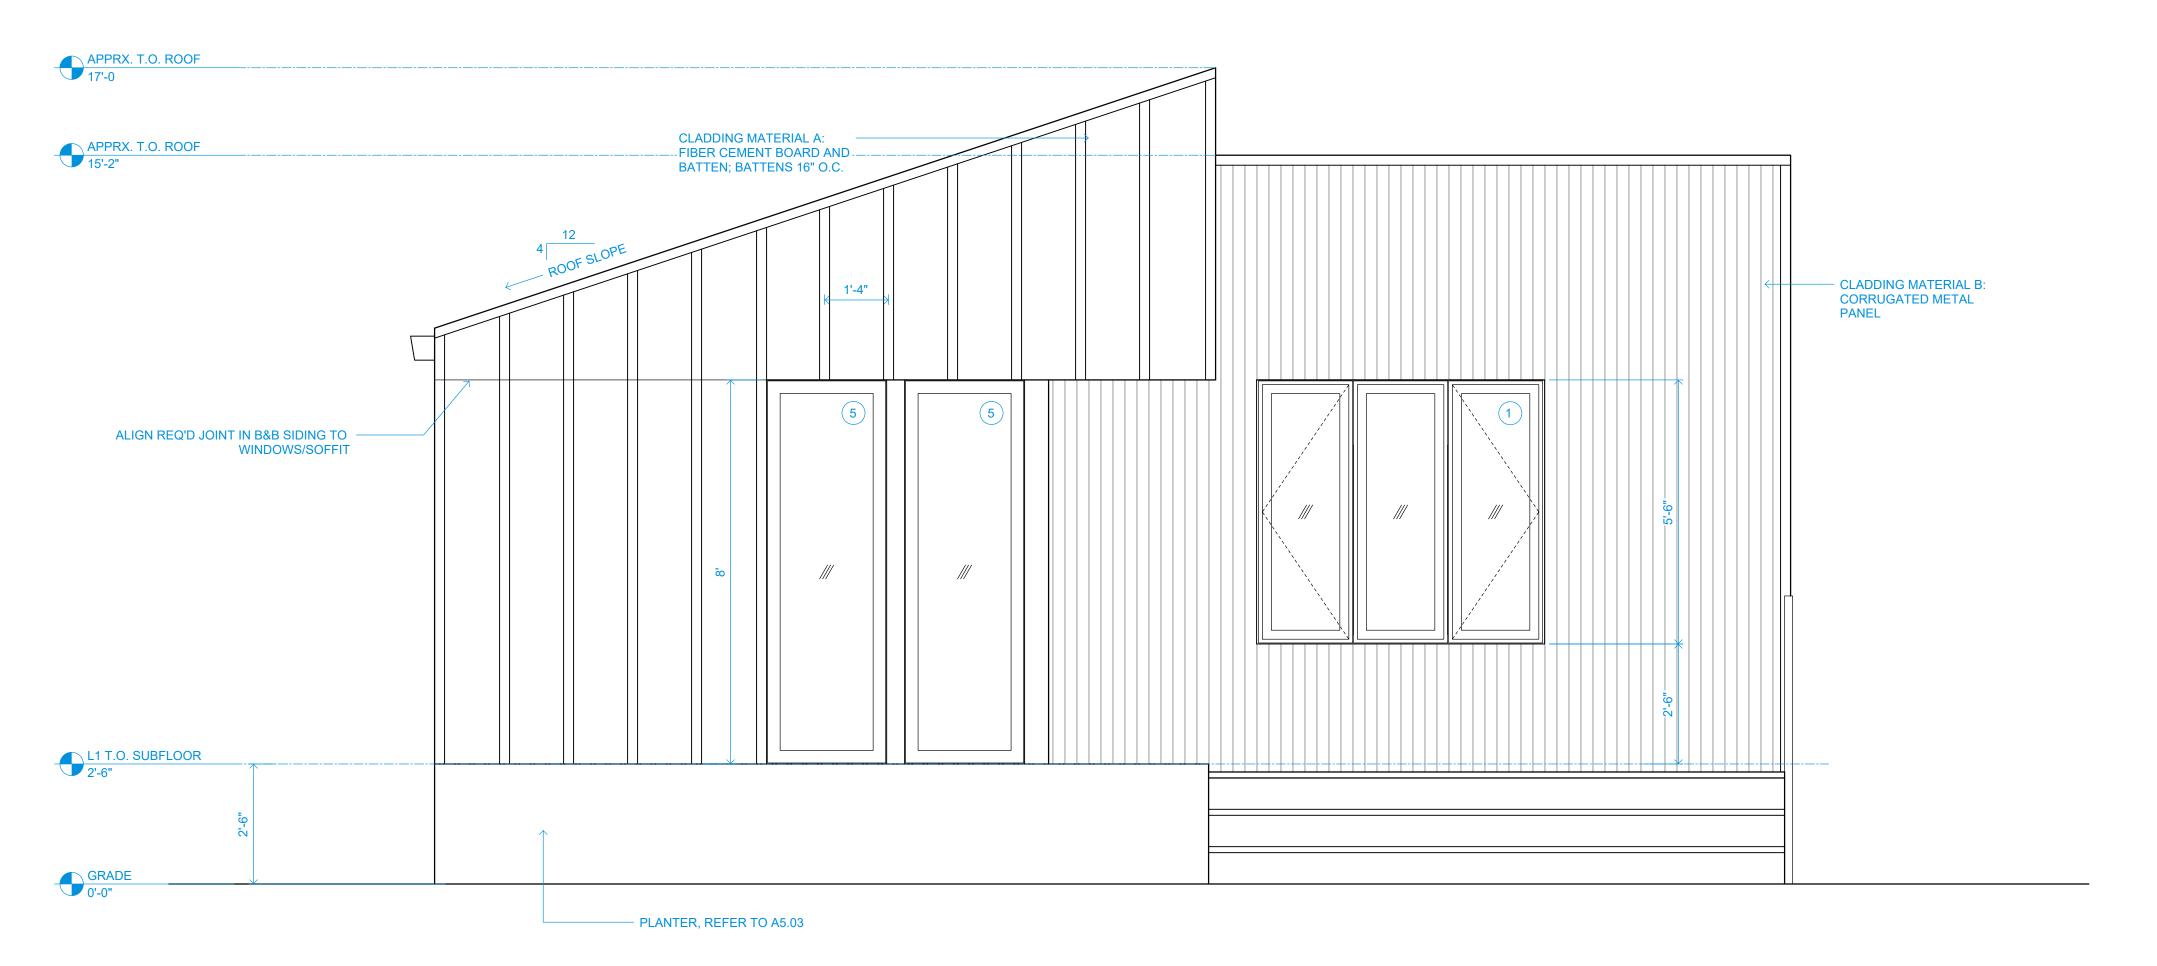

WALL AREA: 346 SQ FT
GLAZING AREA: 73 SQ FT
PERCENT GLAZING: 21%

GLAZING RATIO

GLAZING AREA: 55 SQ FT

PERCENT GLAZING: 18%

301 SQ FT

WALL AREA:

1 FRONT ELEVATION
1/2" = 1'-0"

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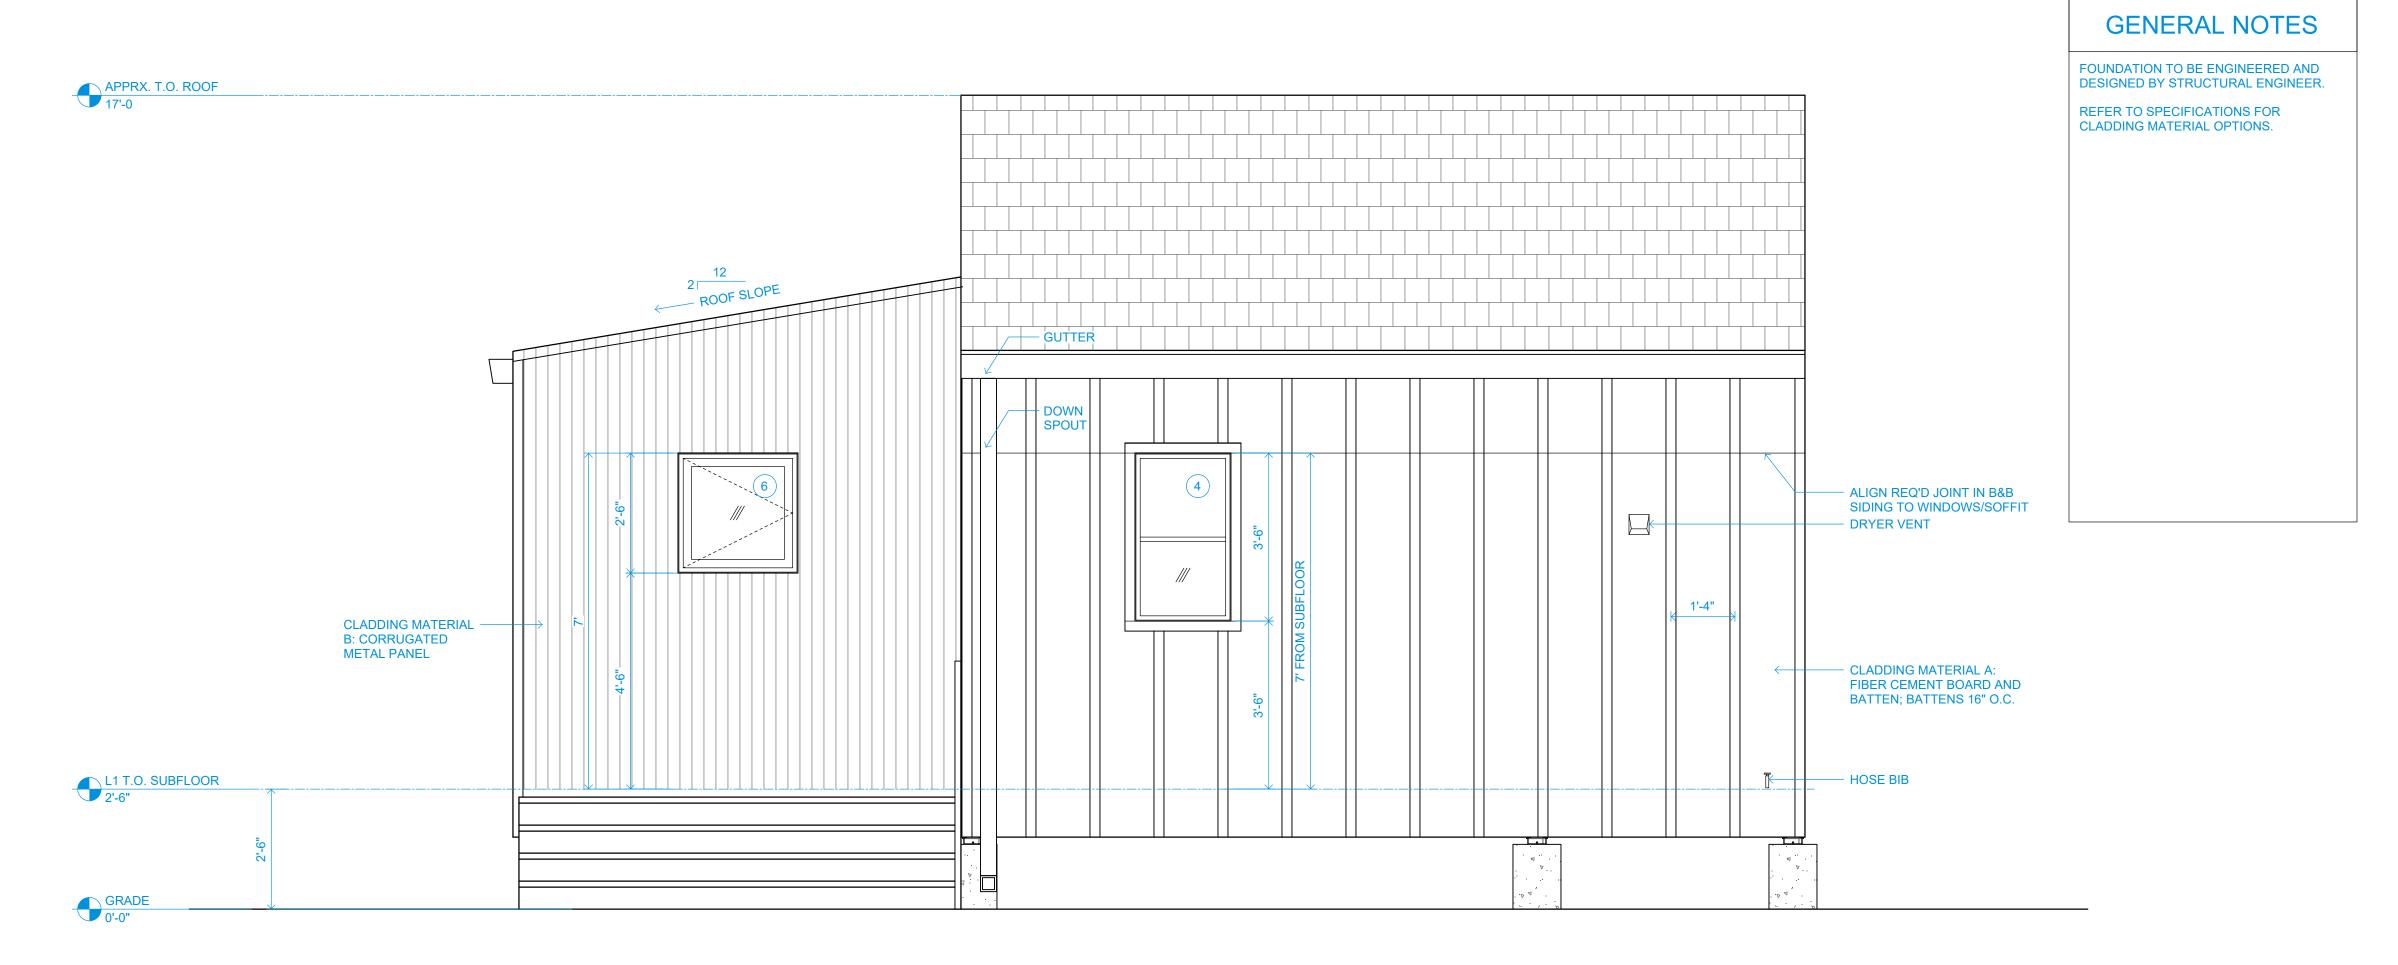
SCALE 1/2" = 1' - 0"

SHEET CONTENTS

ELEVATIONS

SHEET NUMBER

A3.01



AMPRILIO MODI

AMPRIL

GLAZING RATIO

WALL AREA: 368 SQ FT

GLAZING AREA: 54 SQ FT

PERCENT GLAZING: 15%

GLAZING RATIO

WALL AREA:

GLAZING AREA: 13 SQ FT

PERCENT GLAZING: 5%

262 SQ FT

1 RIGHT ELEVATION
1/2" = 1'-0"

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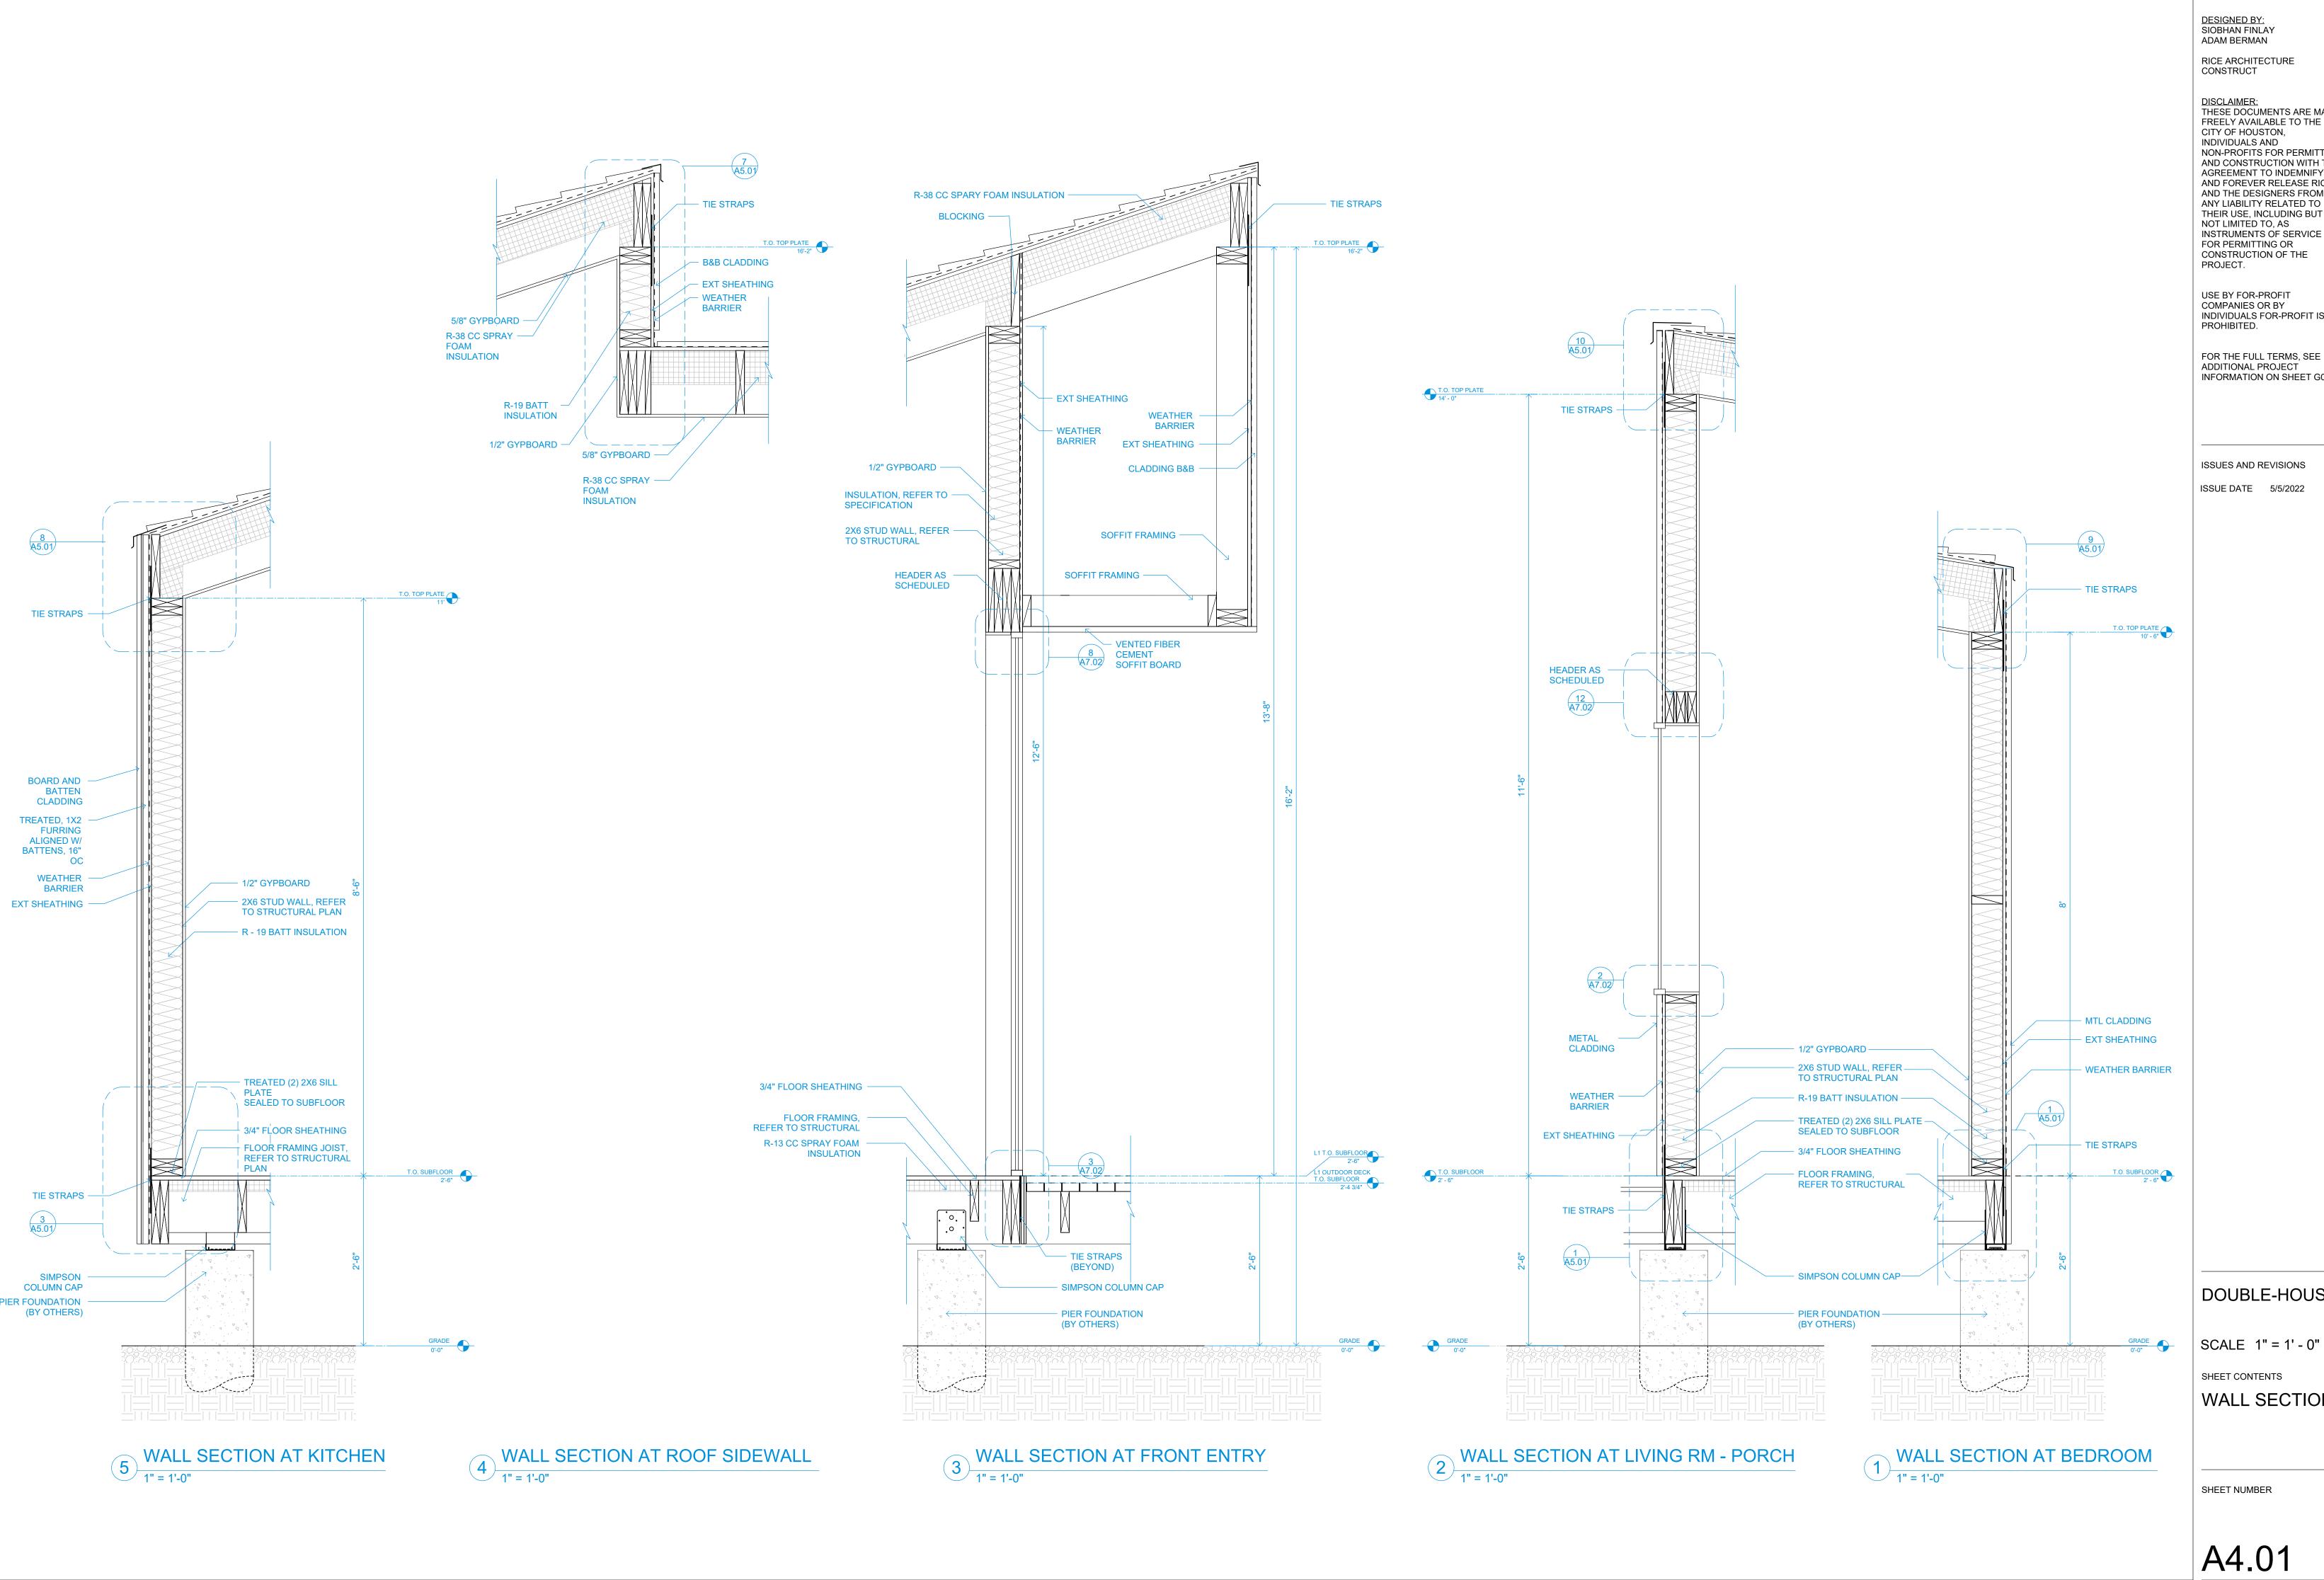
SCALE 1/2" = 1' - 0"

SHEET CONTENTS

ELEVATIONS

SHEET NUMBER

A3.02



RICE ARCHITECTURE


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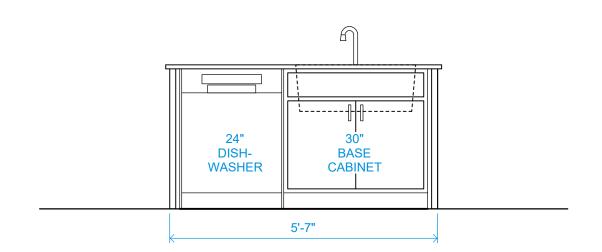
INDIVIDUALS FOR-PROFIT IS

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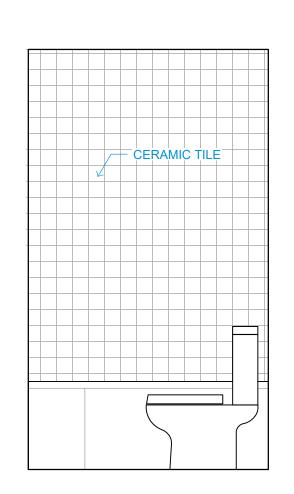
DOUBLE-HOUSE

WALL SECTION



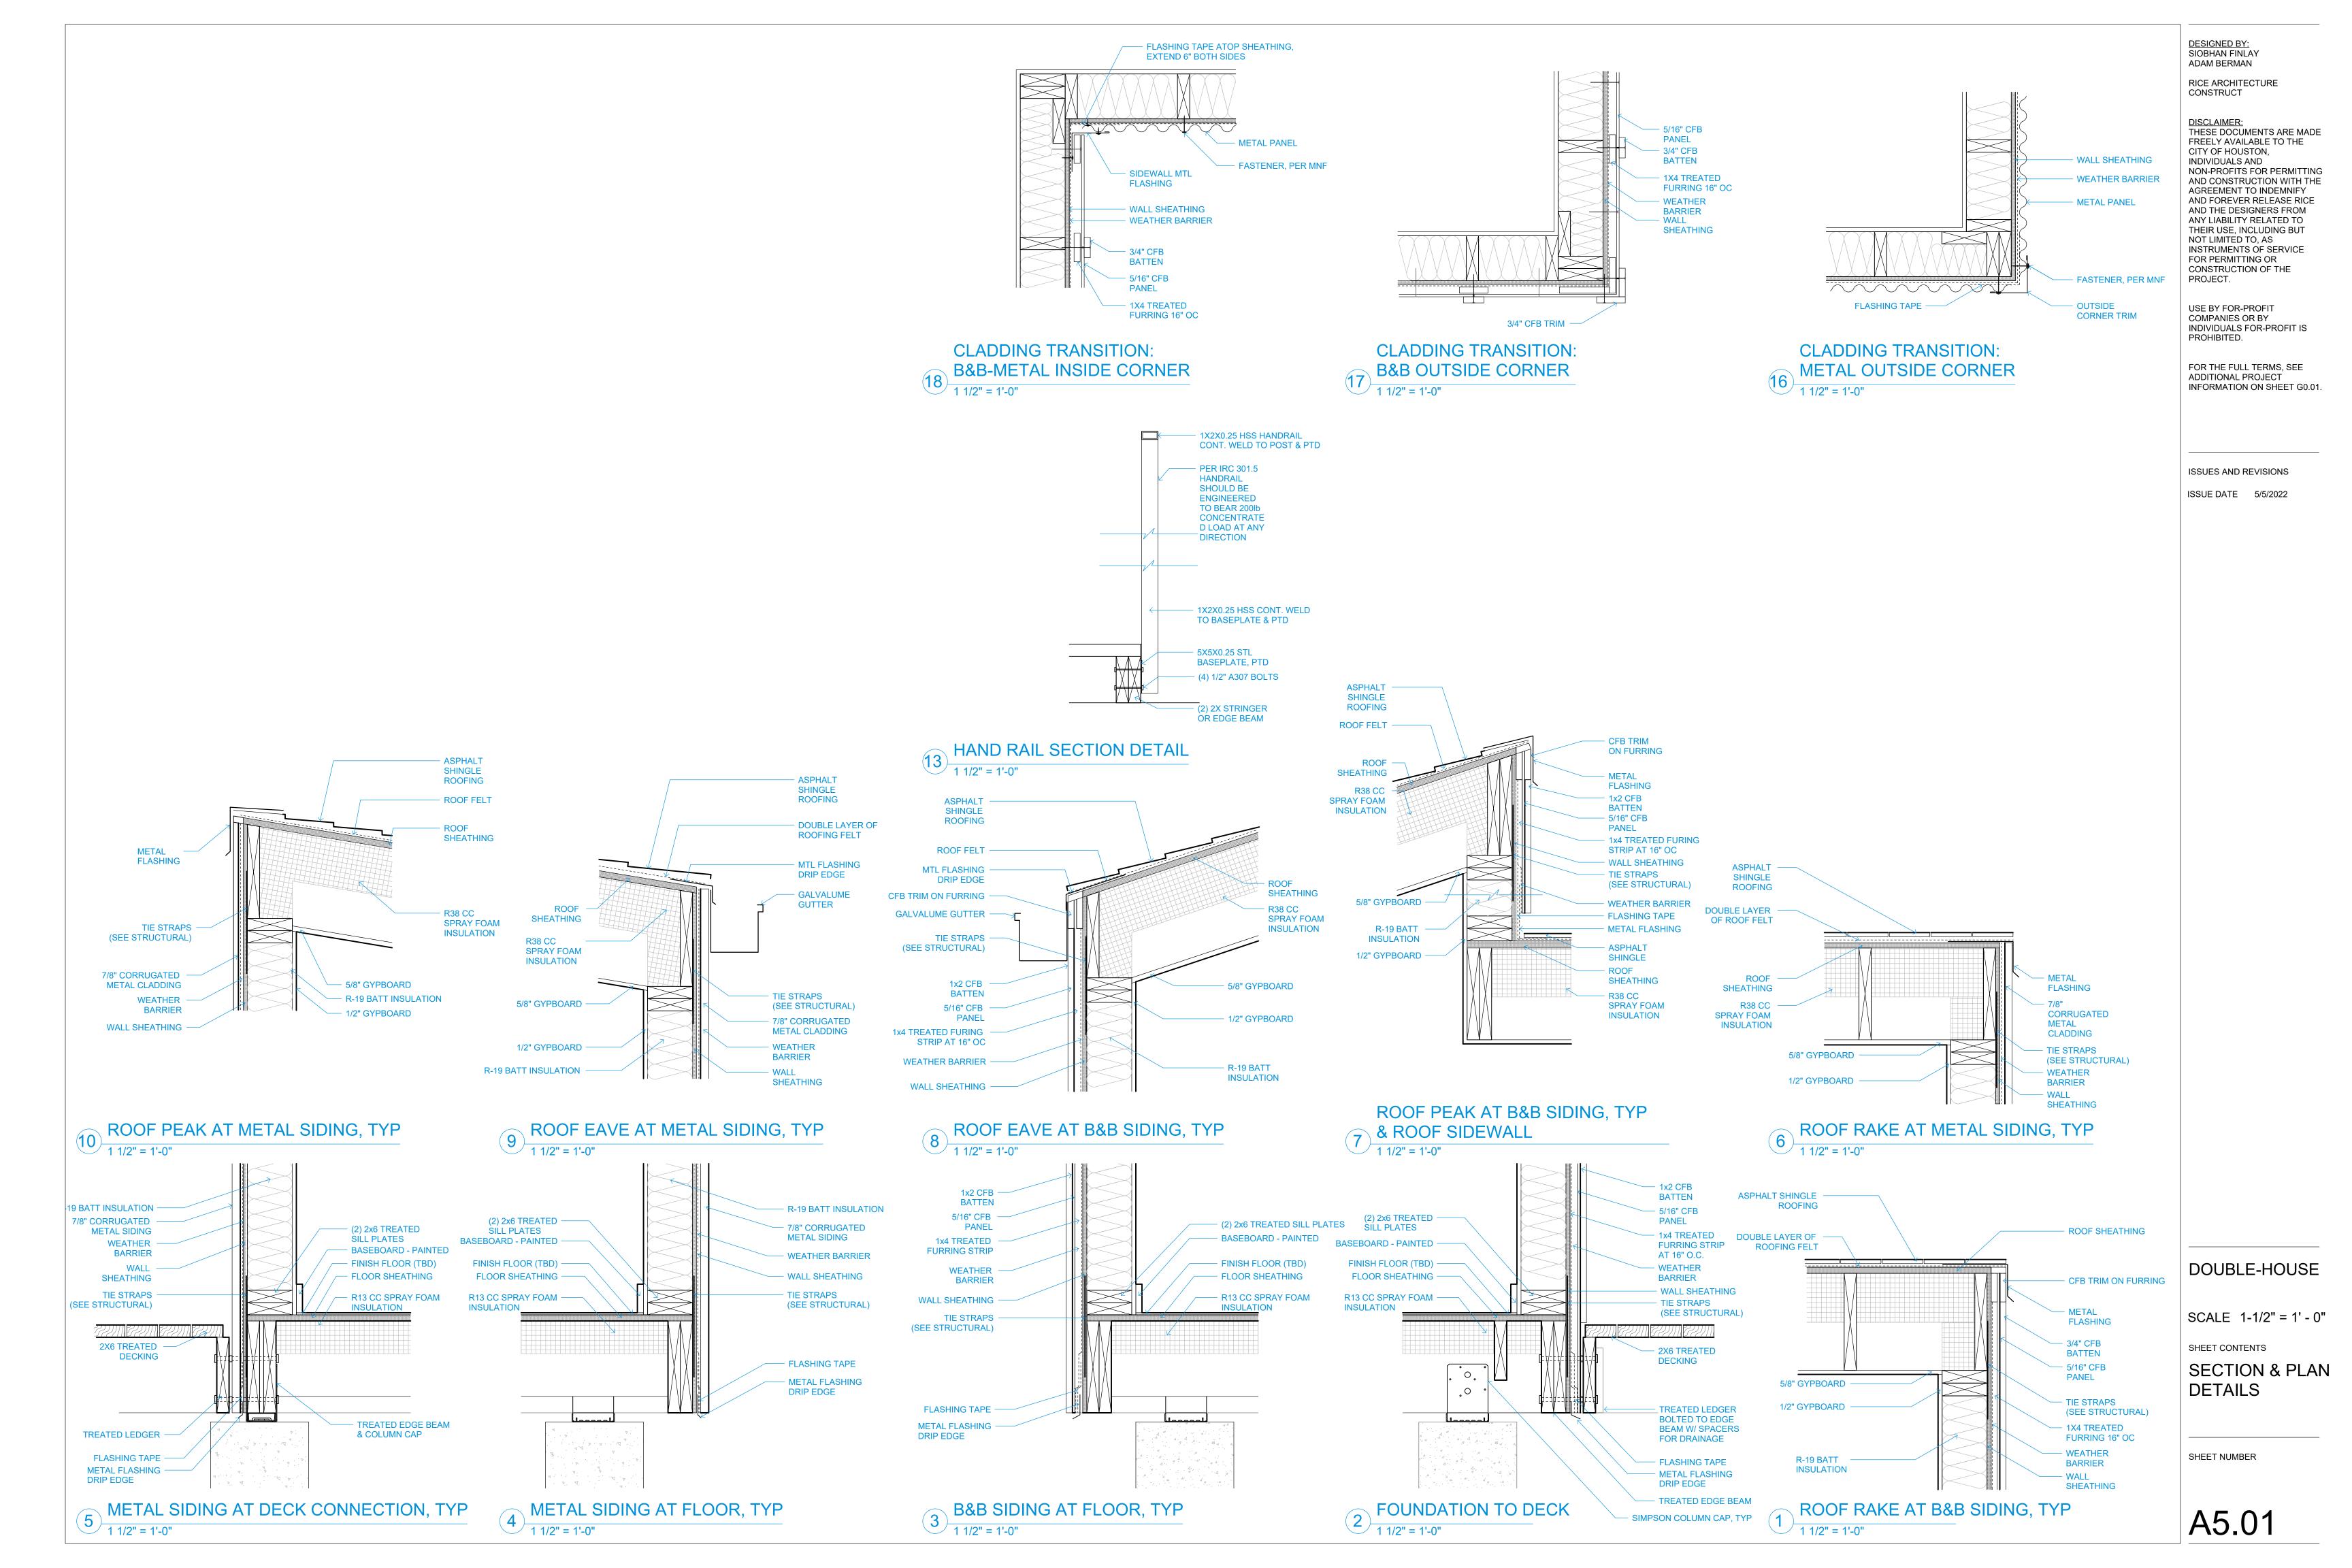


6 KITCHEN ELEVATION
1/2" = 1'-0"




3 BATHROOM ELEVATION
1/2" = 1'-0"



7 LIVINGROOM ELEVATION
1/2" = 1'-0"

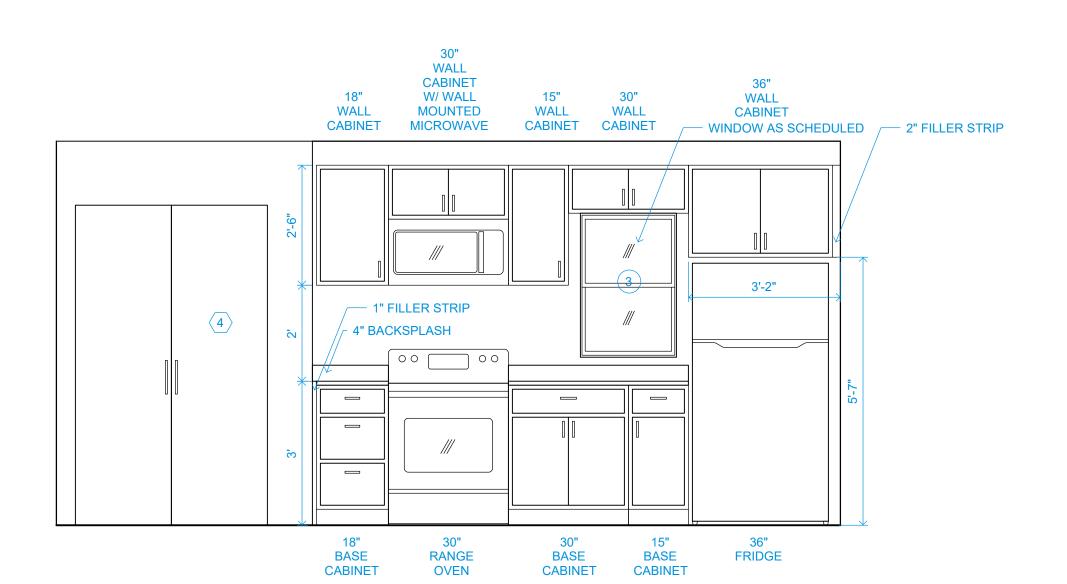


5 KITCHEN ELEVATION
1/2" = 1'-0"

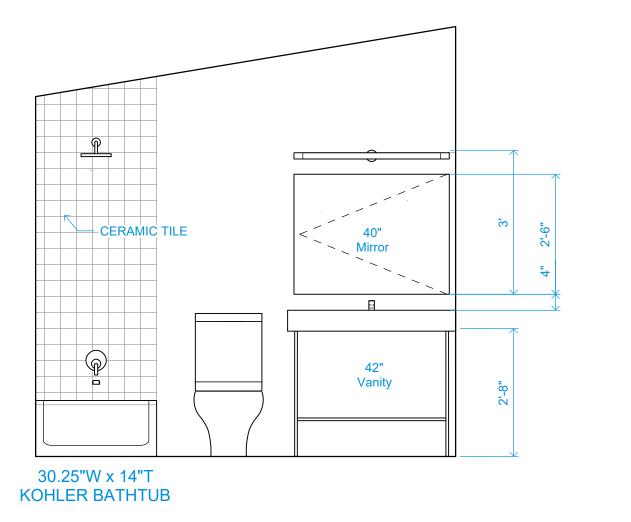

2 BATHROOM ELEVATION
1/2" = 1'-0"



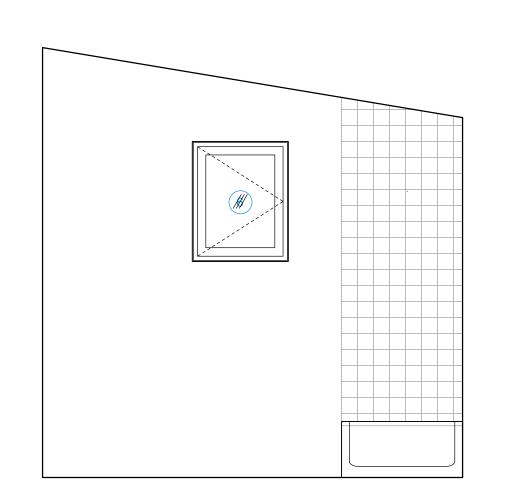

1 BATHROOM ELEVATION
1/2" = 1'-0"

DOUBLE-HOUSE

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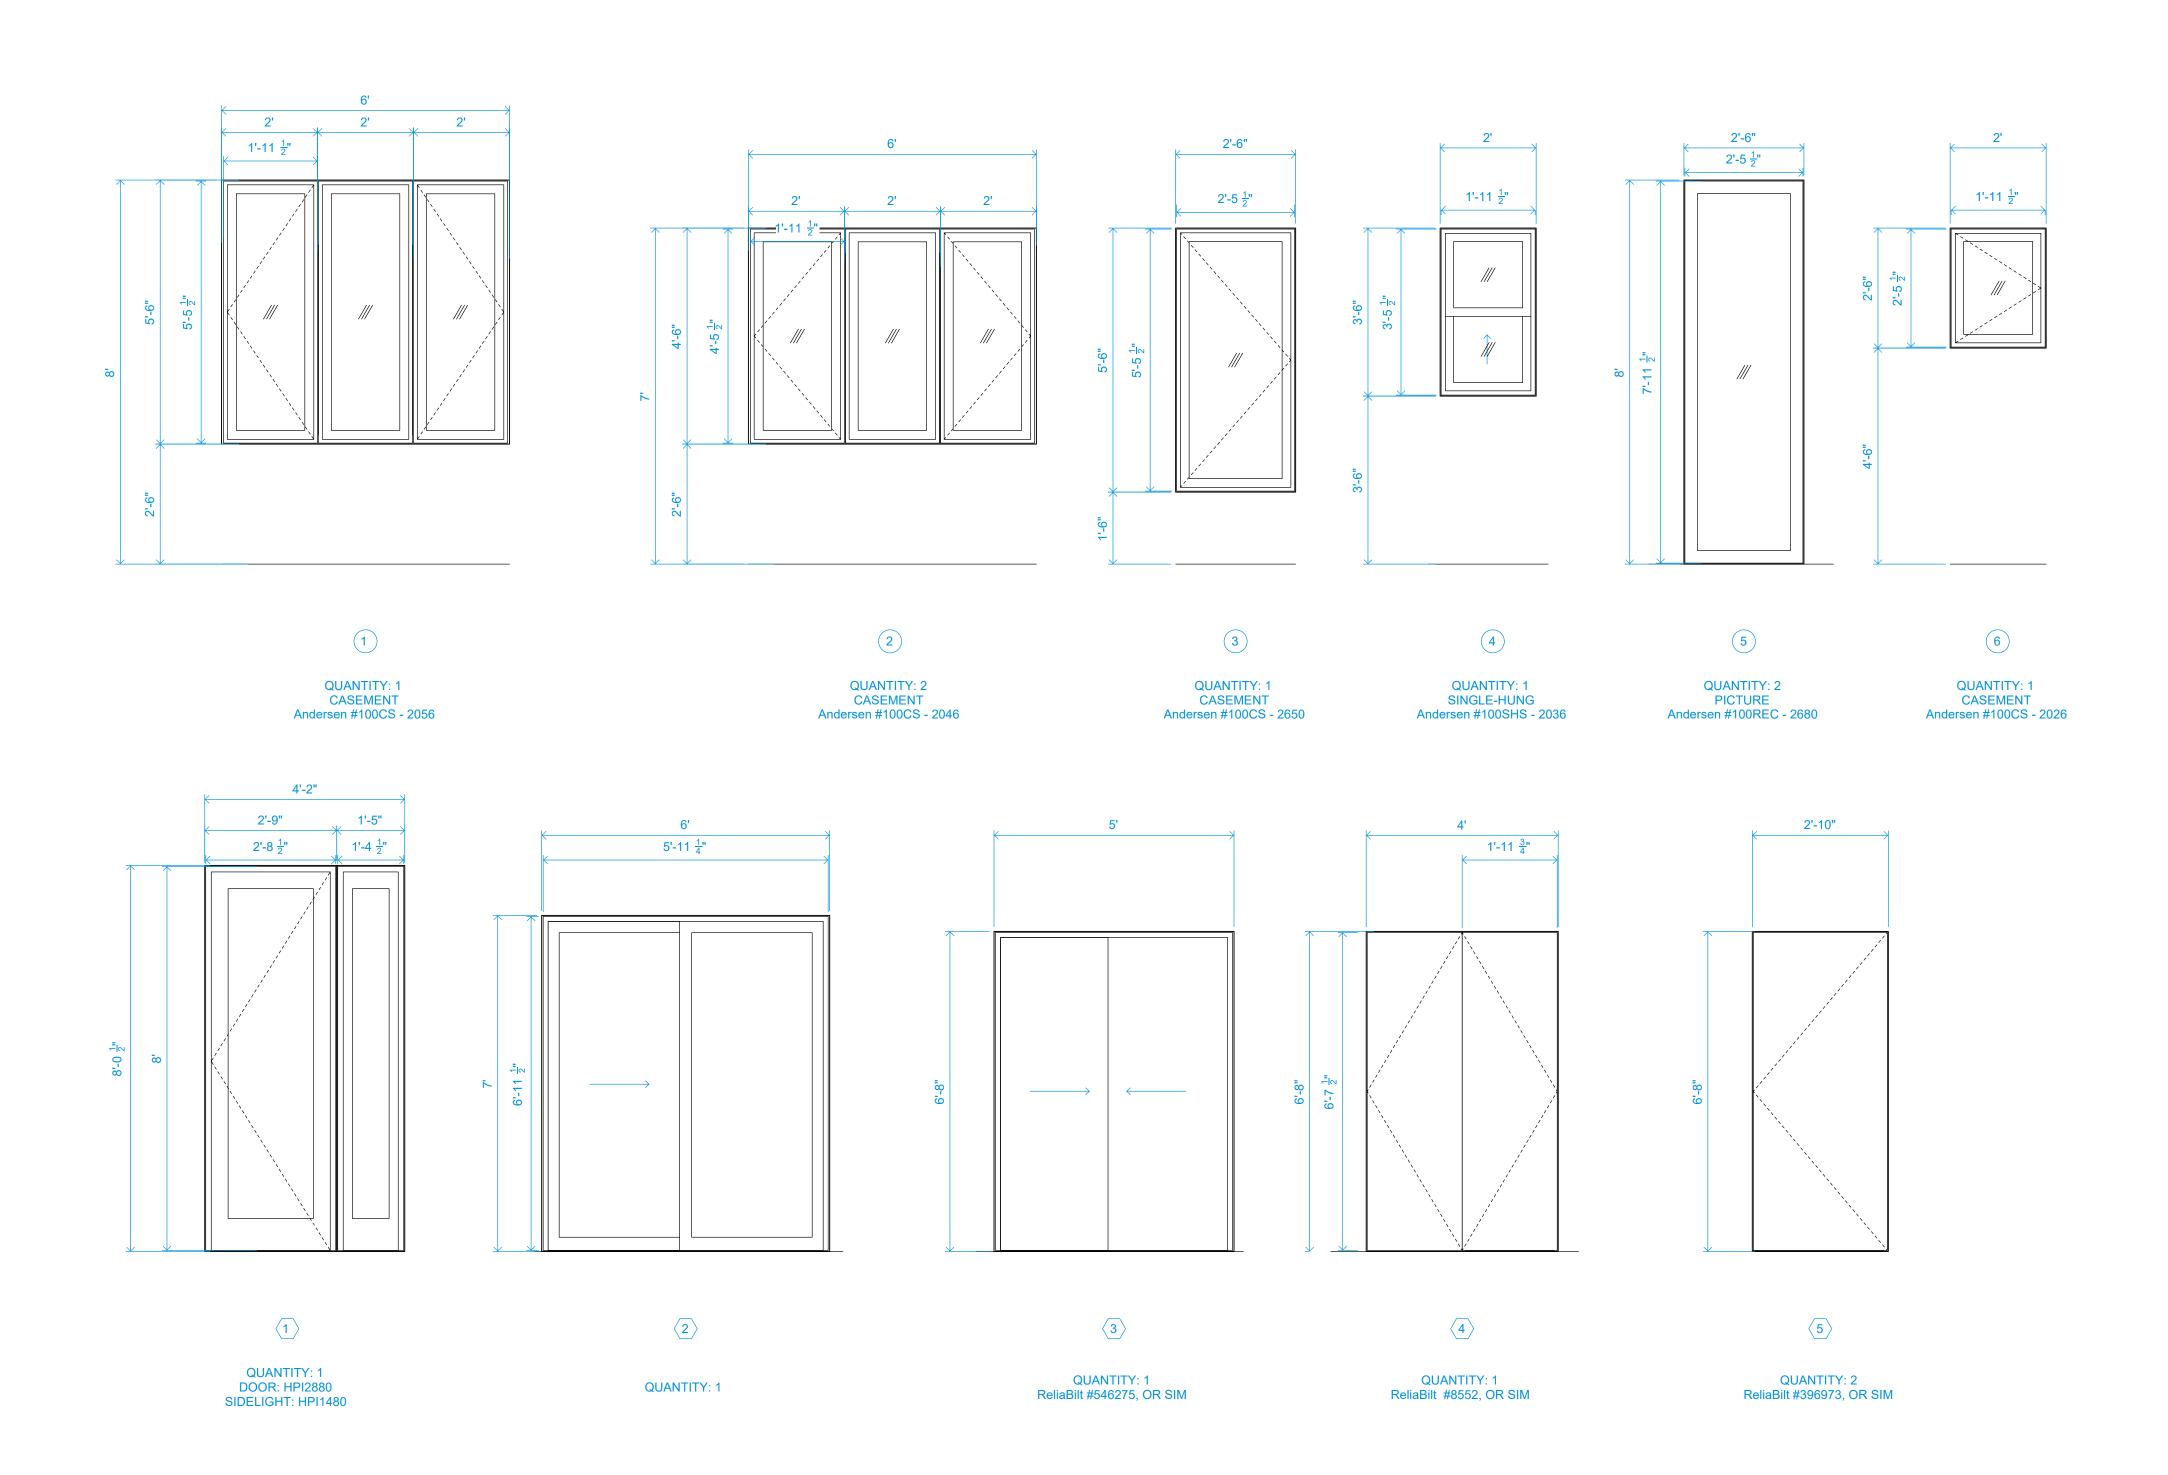
SCALE 1/2" = 1' - 0"

SHEET CONTENTS

INTERIOR ELEVATIONS

SHEET NUMBER

A6.01



WINDOV	V SCHEDULE									
MARK	ROOM	QTY	SIZE (W X H)	SILL HEIGHT	FUNCTION	FINISH	SCREEN	TEMPRD	LOW-E	U-FACTOR
1	LIVING	1	6'-0" x 5'-6"	2'-6"	CASEMENT	VINYL	Υ	N	Υ	0.23 - 0.29
2	LIVING / BEDROOM	2	6'-0" x 4'-6"	2'-6"	CASEMENT	VINYL	Υ	N	Υ	0.23 - 0.29
3	BEDROOM	1	2'-6" x 5'-6"	1'-6"	CASEMENT	VINYL	Υ	N	Υ	0.23 - 0.29
4	KITCHEN	1	2'-0" x 3'-6"	3'-6"	SINGLE-HUNG	VINYL	Υ	N	Υ	0.25 - 0.32
5	ENTRY	2	2'-6" x 8'-0"	0'-0"	PICTURE	VINYL	N	Υ	Υ	0.23 - 0.3
6	BATH	1	2'-0" x 2'-6"	4'-6"	CASEMENT	VINYL	Υ	N	Υ	0.23 - 0.29

DOOR SCHEDULE - EXTERIOR							
MARK	ROOM	QTY	SIZE (W X H)	FUNCTION	OPERATION	TEMPRD	
1	ENTRY (PORCH SIDE)	1	4'-2" x 8'-0"	SWING W/ SIDELITE	LEFT-HAND	Υ	
2	KITCHEN (PORCH SIDE)	1	6'-0" x 7'-0"	SLIDER	XO	Y	

DOOR SCHEDULE - INTERIOR								
MARK	ROOM	TYPE	QTY	SIZE (W X H)	OPERATION			
3	CLOSET	DOUBLE	1	5'-0" x 6'8"	SLIDER			
4	LAUNDRY	DOUBLE	1	4'-0" x 6'8"	LEFT HAND			
5	BED/BATH	SINGLE	2	2'-10" x 6'8"	LEFT HAND			

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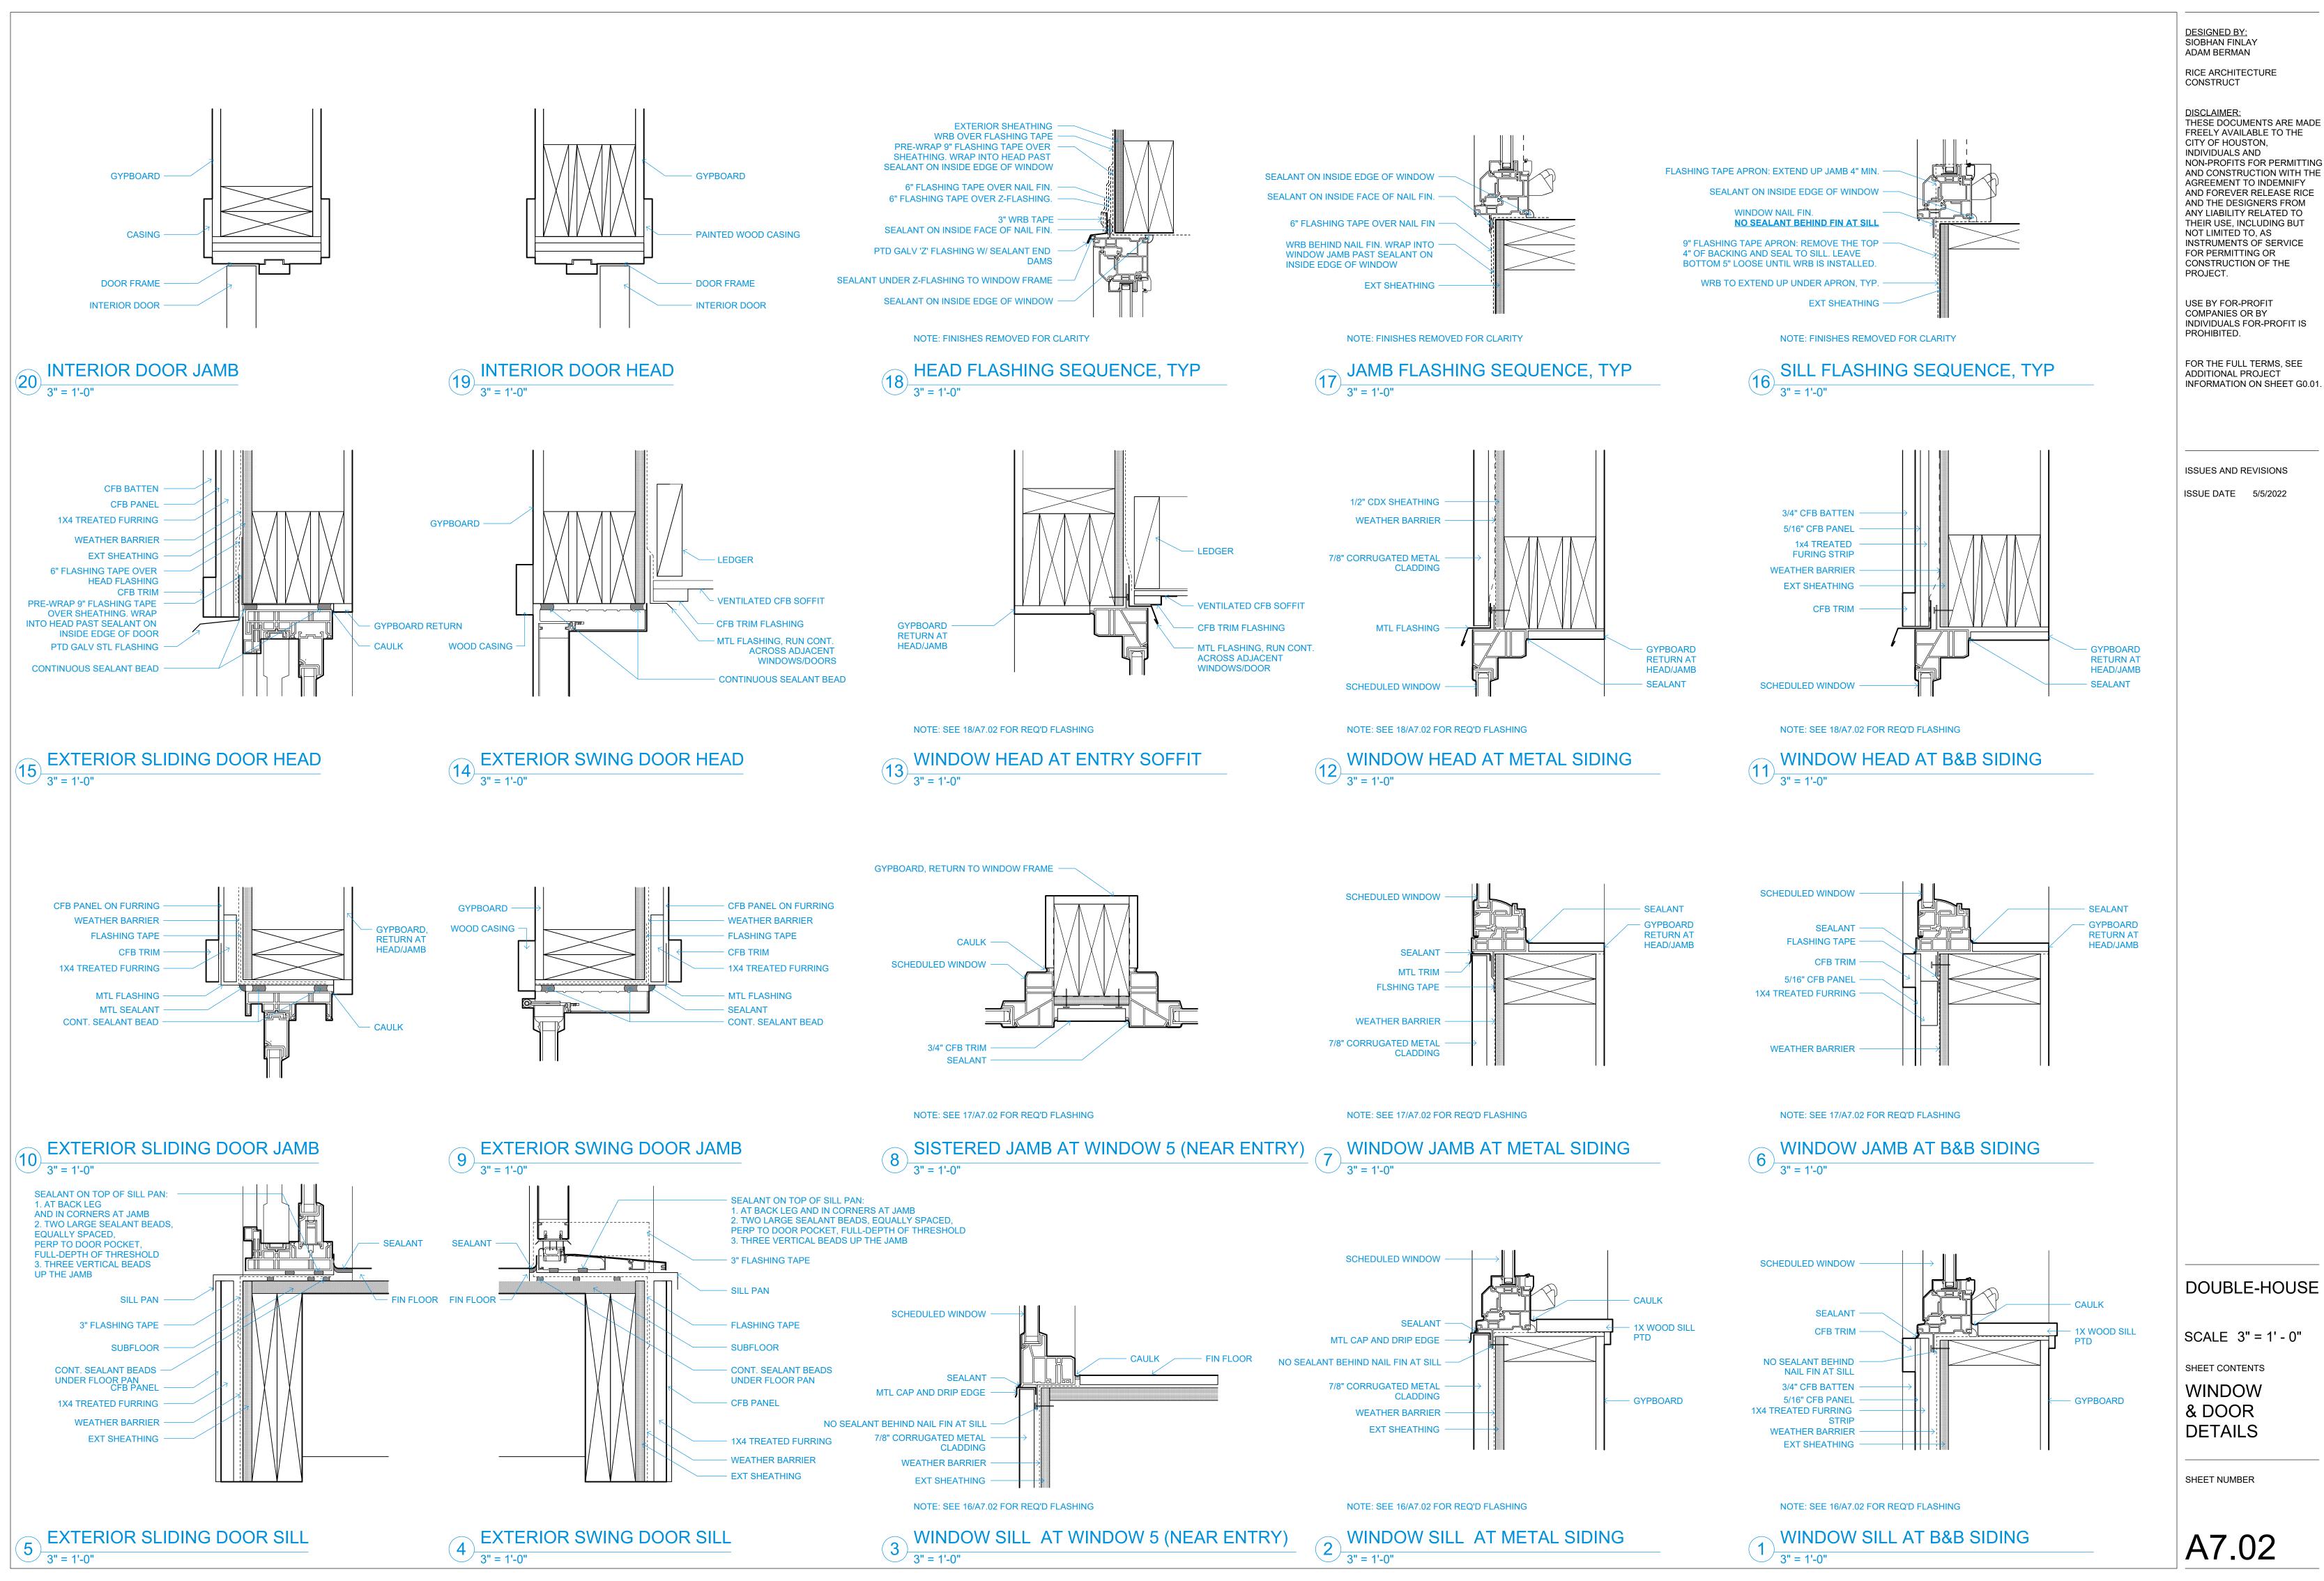
SCALE 1/2" = 1' - 0"

SHEET CONTENTS

WINDOW & DOOR SCHEDULE

SHEET NUMBER

A7.01



HIGH-WIND AREA STRAPPING

THE FOLLOWING REQUIREMENTS ARE EXCERPTED (IN PART) FROM THE HOUSTON AMENDMENTS TO THE 2015 INTERNATIONAL RESIDENTIAL CODE. APPENDIX L:

SECTION AL103 COMPLETE LOAD PATH AND UPLIFT TIES

AL103.1 GENERAL. BLOCKING, BRIDGING, STRAPS, APPROVED FRAMING ANCHORS OR MECHANICAL FASTENERS SHALL BE INSTALLED TO PROVIDE CONTINUOUS TIES FROM THE ROOF TO THE FOUNDATION SYSTEM. TIE STRAPS SHALL BE 1 1/8 INCH (28.6 MM) BY 0.036 INCH (0.91 MM) (NO. 20 GAUGE) SHEET STEEL AND SHALL BE CORROSION RESISTANT AS HEREIN SPECIFIED. ALL METAL CONNECTORS AND FASTENERS USED IN EXPOSED LOCATIONS OR IN AREAS OTHERWISE SUBJECT TO CORROSION SHALL BE OF CORROSION-RESISTANT OR NONCORROSIVE MATERIAL. THE NUMBER OF COMMON NAILS SPECIFIED IS THE TOTAL REQUIRED AND SHALL BE EQUALLY DIVIDED ON EACH SIDE OF THE CONNECTION. NAILS SHALL BE SPACED TO AVOID SPLITTING OF THE WOOD.

AL103.3 SILLS AND FOUNDATION TIE. FOUNDATION PLATES RESTING ON CONCRETE OR MASONRY FOUNDATIONS SHALL BE BOLTED TO THE FOUNDATION WITH NOT LESS THAN ½ INCH DIAMETER (13 MM) ANCHOR BOLTS WITH 7 INCH (178 MM) MINIMUM EMBEDMENT INTO THE FOUNDATION AND SPACED NOT MORE THAN 4 FEET (1,219 MM) ON CENTER.

AL103.4 FLOOR-TO-FOUNDATION TIE. THE LOWEST LEVEL EXTERIOR WALL STUDS SHALL BE CONNECTED TO THE FOUNDATION SILL PLATE OR AN APPROVED ELEVATED FOUNDATION SYSTEM WITH BENT TIE STRAPS SPACED NOT MORE THAN 32 INCHES (813 MM) ON CENTER. TIE STRAPS SHALL BE NAILED WITH A MINIMUM OF 4 TEN PENNY NAILS.

AL103.8 ROOF-MEMBERS-TO-WALL TIE. TIE STRAPS SHALL BE PROVIDED FROM THE SIDE OF THE ROOF-FRAMING MEMBER TO THE SUPPORTING MEMBER BELOW THE ROOF. TIE STRAPS SHALL BE PLACED AT EVERY ROOF FRAMING MEMBER AND CONNECTED WITH A MINIMUM OF 8 EIGHT PENNY NAILS.

STRUCTURAL ABBREVIATIONS

ADD'L.	ADDITIONAL	I.J.	ISOLATION JOINT
ADJ.	ADJACENT	INFO.	INFORMATION
A/E	DESIGN TEAM OF RECORD	INT.	INTERIOR
ALT.	ALTERNATE	JT.	JOINT
ANCH.	ANCHOR	K	KIPS
APPROX.	APPROXIMATE	LB.	POUND
ARCH.	ARCHITECTURAL/ARCHITECT	L.L.	LIVE LOAD
B.O.	BOTTOM OF	LLBB.	LONG LEGS BACK-TO-BACK
BLDG. BM.	BUILDING BEAM	LLH LLV	LONG LEG HORIZONTAL LONG LEG VERTICAL
BOT.	BOTTOM	L.P.	LOW POINT
BRG.	BEARING	L.W.	LIGHTWEIGHT
BSMT.	BASEMENT	MAS.	MASONRY
CANT.	CANTILEVER	MAX.	MAXIMUM
CFS.	COLD FORMED STEEL	MECH.	MECHANICAL
C.I.P.	CAST IN PLACE	MEP	MECH., ELEC., PLUMBING, & FIRE PROTECTION
C.J.	CONTRACTION JOINT	MFR.	MANUFACTURER
CLG.	CEILING	MIN.	MINIMUM
CLR.	CLEAR	MISC.	MISCELLANEOUS
CMU COL.	CONCRETE MASONRY UNIT COLUMN	M.O. M.P.I.I.	MASONRY OPENING MANUFACTURER'S PRINTED
COL.	COMPOSITE	ivial afala	NSTALLATION INSTRUCTIONS
CONC.	CONCRETE	N.F.	NEAR FACE
CONST.	CONSTRUCTION	N.I.C.	NOT IN CONTRACT
CONT.	CONTINUOUS	NO.	NUMBER
COORD.	COORDINATE/COORDINATION	N.S.	NEAR SIDE
CONTR.	CONTRACTOR	N.T.S.	NOT TO SCALE
COTR	CONTRACTING OFFICER'S TECHNICAL REP.	N.W.	NORMAL WEIGHT
CTR.	CENTER	O.C.	ON CENTER
DBL. DEMO.	DOUBLE DEMOLITION/DEMOLISH	O.D. O.F.	OUTSIDE DIAMETER
DEMO.	DETAIL	O.F. OPNG.	OUTSIDE FACE OPENING
DIA.	DIAMETER	OPP.	OPPOSITE
DIAG.	DIAGONAL	PC.	PIERCE
DIM.	DIMENSION	PED.	PEDESTAL
D.L.	DEAD LOAD	PERP.	PERPENDICULAR
DN.	DOWN	PL.	PLATE
DWG(S).	DRAWING(S)	PLG	POUNDS PER LINEAR FOOT
	DOWEL	PREFAB. PSF	PREFABRICATED POUNDS PER SQUARE FOOT
EA. E.O.	EACH EDGE OF	PSI	POUNDS PER SQUARE INCH
E.F.	EACH FACE	REINF.	REINFORCE(D), REINFORCEMENT
EXIST.	EXISTING	REQ'D.	REQUIRED
EXP.	EXPANSION JOINT	REV.	REVISION
EL.	ELEVATION	SCHED.	SCHEDULE
ELEC.	ELECTRICAL	SECT.	SECTION
ELEV.	ELEVATOR	SIM.	SIMILAR
EMBED.	EMBEDMENT	SLBB	SHORT LEGS BACK-TO-BACK
ENGR. E.O.R.	ENGINEER ENGINEER OF RECORD	S.O.G. SPEC	SLAB ON GRADE SPECIFICATION
EQ.	EQUAL	SQ.	SQUARE
EXP. JT.	EXPANSION	S.S.	STAINLESS STEEL
EXT.	EXTERIOR	STD	STANDARD
E.W.	EACH WAY	STIFF.	STIFFENER
FDN.	FOUNDATION	STL.	STEEL
FIN.	FINISH	S-W	SHORT WAY
FLR.	FLOOR	SYM.	SYMMETRIC
FRMG. F.S.	FRAMING FAR SIDE	T.O. T & B	TOP OF TOP & BOTTOM
F.S. FT.	FEET	TEMP.	TEMPORARY/TEMPERATURE
FTG.	FOOTING	TYP.	
GA.	GAGE/GAUGE	U.N.O.	UNLESS NOTED OTHERWISE
GALV.	GALVANIZED	VERT.	VERTICAL
G.B.	GRADE BEAM	W/	WITH
HDR.	HEADER	W.P.	WORK POINT
HGR.	HANGER	W.W.R.	WELDED WIRE REINFORCEMENT
HORIZ.	HORIZONTAL	#	NUMBER/SIZE
H.P. HT.	HIGH POING HEIGHT		
HVAC	HEATING, VENTILATION, & AIR CONDITIONING	G	

HEATING, VENTILATION, & AIR CONDITIONING **INSIDE DIAMETER**

INSIDE FACE

STANDARD ABBREVIATIONS FOR WOOD STRUCTURES

NOM. NOMINAL R.O. ROUGH OPENING T & G **TONGUE AND GROOVE**

FRAMING LUMBER

1. ALL FRAMING LUMBER WORK SHALL CONFORM TO THE FOLLOWING GOVERNING A.AMERICAN WOOD COUNCIL "WOOD FRAME CONSTRUCTION MANUAL FOR ONE AND TWO FAMILY DWELLINGS". B.AMERICAN WOOD COUNCIL "NATIONAL DESIGN SPECIFICATION FOR WOOD CONSTRUCTION," "NDS SUPPLEMENT: DESIGN VALUES

FOR WOOD CONSTRUCTION", AND "SPECIAL DESIGN PROVISIONS FOR WIND AND SEISMIC".

2. FRAMING LUMBER SHALL HAVE EACH PIECE GRADE STAMPED, SHALL BE SURFACED DRY (EXCEPT STUDS, WHICH SHALL BE KILN DRIED) AND SHALL CONFORM TO THE **FOLLOWING SPECIES AND GRADE:** RAFTERS AND JOISTS: SOUTHERN YELLOW PINE #1. BEAMS, GIRDERS AND HEADERS: SOUTHERN YELLOW PINE #1.

3. TIMBER LUMBER SHALL CONFORM TO THE FOLLOWING SPECIES AND GRADE: POST AND TIMBER: SOUTHERN YELLOW PINE #1.

STUDS AND PLATES: SOUTHERN YELLOW PINE STUD GRADE.

BEAMS AND STRINGERS: SOUTHERN YELLOW PINE #1.

4. PRESERVATIVE-TREATED WOOD: PROVIDE TREATED LUMBER COMPLYING WITH ACQ-D (CARBONATE). COPPER AZOLE (CA-B), OR SODIUM BORATE (SBX (DOT) WITH NaS10/2) AT ALL LUMBER IN CONTACT WITH CONCRETE OR MASONRY, OR AS OTHERWISE INDICATED ON ARCHITECTURAL OR STRUCTURAL DRAWINGS. ACZA TREATMENT IS NOT PERMITTED. TREATED LUMBER AND/OR PLYWOOD SHALL BEAR THE LABEL OF AN ACCREDITED AGENCY SHOWING 0.40 PCF RETENTION. WHERE LUMBER AND/OR PLYWOOD IS CUT OR DRILLED AFTER TREATMENT. THE TREATED SURFACE SHALL BE FIELD-TREATED WITH COPPER NAPTHENATE (THE CONCENTRATION OF WHICH SHALL CONTAIN A MINIMUM OF 2% COPPER METAL) BY REPEATED BRUSHING, DIPPING, OR SOAKING UNTIL THE WOOD ABSORBS NO MORE PRESERVATIVE. REFER TO NOTES 2 AND 3 FOR SPECIES AND GRADE OF WOOD UNLESS OTHERWISE NOTED ON PLAN.

5. ALL WOOD FRAMING INCLUDING DETAILS FOR BRIDGING, BLOCKING, FIRE STOPPING, ETC., SHALL CONFORM TO THE "NATIONAL DESIGN SPECIFICATION FOR WOOD CONSTRUCTION" AND ITS SUPPLEMENTS AND SHALL BE INSTALLED IN ACCORDANCE WITH THE NFPA "MANUAL FOR HOUSE FRAMING" OR THE GOVERNING LOCAL/STATE BUILDING CODE.

6. FASTENING SHALL BE IN ACCORDANCE WITH THE MOST RESTRICTIVE OF: THE GOVERNING LOCAL/STATE BUILDING CODE, OR THE MANUFACTURER'S RECOMMENDED FASTENING SCHEDULES.

7. ALL FLUSH FRAMED CONNECTIONS SHALL BE MADE WITH APPROVED GALVANIZED STEEL JOIST OR BEAM HANGERS, MINIMUM 18 GAUGE, INSTALLED ACCORDING TO MANUFACTURER'S RECOMMENDATIONS.

8. STUD BEARING WALLS ARE TO BE 2x6 @ 16" O.C. AT THE INTERIOR AND 2x6 @ 16" O.C. AT THE EXTERIOR, UNLESS NOTED OTHERWISE ON PLAN.

9. ALL RAFTERS AND JOISTS SHALL ALIGN DIRECTLY WITH STUDS BELOW. WHERE REQUIRED INSTALL ADDITIONAL STUDS.

10. LAP ALL PLATES AT CORNERS AND AT INTERSECTION OF PARTITIONS.

11. STAGGER ALL TOP AND BOTTOM PLATE SPLICES A MINIMUM OF 32 INCHES.

12. USE DOUBLE STUDS @ ENDS OF WALL AND ENDS OF WALL OPENINGS.

13. AT THE ENDS OF ALL BEAMS, HEADERS AND GIRDERS PROVIDE A BUILT UP OR SOLID POST WHOSE WIDTH IS AT LEAST EQUAL TO THE WIDTH OF THE MEMBER IT IS SUPPORTING AND WHOSE DEPTH IS 6" (NOM.) AT INTERIOR WALLS AND 6" (NOM.) AT EXTERIOR WALLS UNLESS OTHERWISE NOTED.

14. BUILT UP (3) 2X6 OR SOLID 4-1/2"X5-1/2" POSTS REQUIRED TO SUPPORT ROOF BEAMS AND GIRDERS WHERE INDICATED IN PLANS. SEE S1.21

15. USE DOUBLE TRIMMERS AND HEADERS AT ALL FLOOR OPENINGS WHERE BEAMS ARE NOT DESIGNATED.

16. PROVIDE CROSS BRIDGING AT A MAXIMUM OF 8' O.C.

17. BUILT UP BEAMS LESS THAN 8" DEEP SHALL BE SPIKED TOGETHER WITH 2 - 16D NAILS @16" O.C. BUILT UP BEAMS GREATER THAN 8" DEEP SHALL BE SPIKED TOGETHER WITH 3 - 16D NAILS @16" O.C.

18. WHERE THERE IS NO PLYWOOD WALL SHEATHING, PROVIDE DIAGONALS AT ALL EXTERIOR CORNERS OF STUD WALLS AT EACH FLOOR. (1" x 4" BRACES LET INTO STUDS AND NAILED AT EACH STUD CROSSING WITH 2 - 10D NAILS.)

19. WHERE CANTILEVERED BEAMS ARE INDICATED, THE FAR CONNECTOR SHALL BE CAPABLE OF RESISTING AN UPLIFT OF 1000 LBS. MIN., U.N.O.

20. NO NEW OR EXISTING JOISTS SHALL BE CUT OR NOTCHED WITHOUT APPROVAL.

WOOD HEADER SCHEDULE

ROUGH OPENING WIDTH	HEAD)ER
	2x4 WALL	2x6 WALL
LESS THAN 3'-0"	(10) 2x6	(10) 2x6
3'-1 TO 4'-0"	(8) 2x6	(8) 2x6
4'-1" TO 6'-0"	(10) 2x6	(10) 2x6
6'-1" TO 8'-0"	(0) 2x6	(0) 2x6
OVER 8'-0" SEE PLANS	SEE PLANS	SEE PLANS

NOTE: PROVIDE SIMPSON HH HEADER HANGERS FOR SPANS LESS THAN 4'-0' WIDE, (2) JACK STUDS FOR SPANS LESS THAN 8'-0" WIDE, (3) JACK STUDS FOR SPANS OVER 8'-0" WIDE.

21. ALL LIGHT-GAUGE HANGERS SUPPORTING PRESERVATIVE TREATED WOOD SHALL MEET OR EXCEED G185 (1.85 OZ OF ZINC PER SQUARE FOOT). ALTERNATIVELY, STAINLESS STEEL CONNECTIONS MAY BE USED. FASTENERS SHALL MATCH THE HANGER FINISH AND MATERIAL.

FRAMING LUMBER (CONT.)

22. WHERE JOIST ORIENTATION IS PARALLEL TO EXTERIOR STUD OR FOUNDATION WALLS, PROVIDE FULL-SECTION BLOCKING FOR 3 BAYS @ 4'-0" O.C. MAX. WHERE SHEATHING IS NOT CONTINUOUSLY FASTENED TO TOP OR BOTTOM OF JOIST. PROVIDE 18 GA x 1-1/2" x 1'-0" (MIN.) FLAT TENSION STRAP BETWEEN ALIGNED **BLOCKING MEMBERS.**

GENERAL NOTES

- 1. ALL STRUCTURAL WORK SHALL BE COORDINATED WITH ARCHITECTURAL AND MECHANICAL DRAWINGS AND SHALL CONFORM TO THE PROJECT SPECIFICATIONS, INCLUDING THE 2015 IRC BUILDING CODE. ALL GOVERNING STANDARDS LISTED IN THESE NOTES SHALL BE THE EDITION REFERENCED IN THIS GOVERNING CODE.
- CONTRACTOR SHALL PROVIDE TEMPORARY SHORING, BRACING, SHEETING AND MAKE SAFE ALL FLOORS, ROOFS, WALLS AND ADJACENT PROPERTY AS PROJECT CONDITIONS REQUIRE. SHORING AND SHEETING SHALL BE DESIGNED BY A REGISTERED PROFESSIONAL ENGINEER LICENSED IN THE PROJECT JURISDICTION HIRED BY THE CONTRACTOR WHO SHALL SUBMIT SHOP DRAWINGS AND CALCULATIONS FOR THE OWNER'S REVIEW.

FOUNDATIONS

1. BUILDING FOUNDATION DESIGN IS EXCLUDED

PIER OR SLAB FOUNDATIONS SHOULD BE DESIGNED BY A LICENSED ENGINEER AND SUBMITTED WITH AN ENGINEER'S SEAL AT THE TIME OF PERMIT APPLICATION.

2. THE INDICATED WOOD-FRAMED BUILDING IS DESIGNED TO BEAR ON PIER LOCATIONS INDICATED IN DRAWINGS OR ON A CONCRETE SLAB AS SHOWN IN THE INCLUDED ALTERNATE.

CONCRETE PIERS OR SLABS ARE SHOWN ONLY TO INDICATE THEIR RELATIVE POSITION TO THE WOOD-FRAME STRUCTURE. PIER AND SLAB STRUCUTRAL DIMENSIONS ARE NOTIONAL AND SHOULD NOT BE SCALED FROM DRAWINGS.

WOOD STRUCTURAL PANEL SHEATHING

- 1. PROVIDE STRUCTURAL I PLYWOOD SHEATHING WITH BOND CLASSIFICATIONS APPROPRIATE TO THE END USE: "EXTERIOR" (PERMANENT EXPOSURE), OR "EXPOSURE I" (CONSTRUCTION EXPOSURE ONLY)
- 2. FLOOR SHEATHING: NOM. 3/4 " THICK T&G PLYWOOD (48/24 SPAN RATING), APA STURD-I-FLOOR, OR ADVANTECH SUBFLOOR.
- 3. ROOF SHEATHING (STANDARD): NOM. 5/8" THICK T&G PLYWOOD (48/24 SPAN RATING).
- 4. ROOF SHEATHING (UNDER SLATE OR CLAY TILE): NOM. 3/4 " THICK T&G PLYWOOD (48/24 SPAN RATING).
- 5. WALL SHEATHING (STANDARD: NOM. 1/2" THICK PLYWOOD (32/16 SPAN RATING).
- 6. WALL SHEATHING (BEHIND SLATE, CLAY TILE, OR MASONRY VENEER): NOM. 3/4 " THICK PLYWOOD (48/24 SPAN RATING).
- 7. LEAVE 1/16" SPACE AT ALL PLAYWOOD PANEL END JOINTS AND 1/8" SPACE AT ALL PANEL EDGE JOINTS.
- 8. UNLESS NOTED OTHERWISE, WALL SHEATHING SHALL BE FASTENED TO FRAMING WITH 8D COMMON NAILS @ 4" O.C. AT EACH SHEET PERIMETER AND 12" O.C. ELSEWHERE. PROVIDE 2X6 BLOCKING AT ALL FREE EDGES.
- 9. UNLESS NOTED OTHERWISE, ROOF SHEATHING SHALL BE FASTENED TO FRAMING WITH 8D COMMON NAILS @ 6" O.C AT EACH SHEET PERIMETER AND 12" O.C. ELSEWHERE.
- 10. ALL FLOOR SHEATHING SHALL BE GLUED AND SCREWWED TO FLOOR JOISTS USING AN APA APPROVED ADHESIVE AND #8 SCREWS @ 6" O.C. AT EACH SHEET PERIMETER AND 12" O.C. ELSEWHERE, UNLESS NOTED OTHERWISE.

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RICE ARCHITECTURE CONSTRUCT

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ISSUES AND REVISIONS

ISSUE DATE 5/5/2022


DOUBLE-HOUSE

SCALE NTS

NOTES

SHEET CONTENTS **STRUCTURAL**

SHEET NUMBER

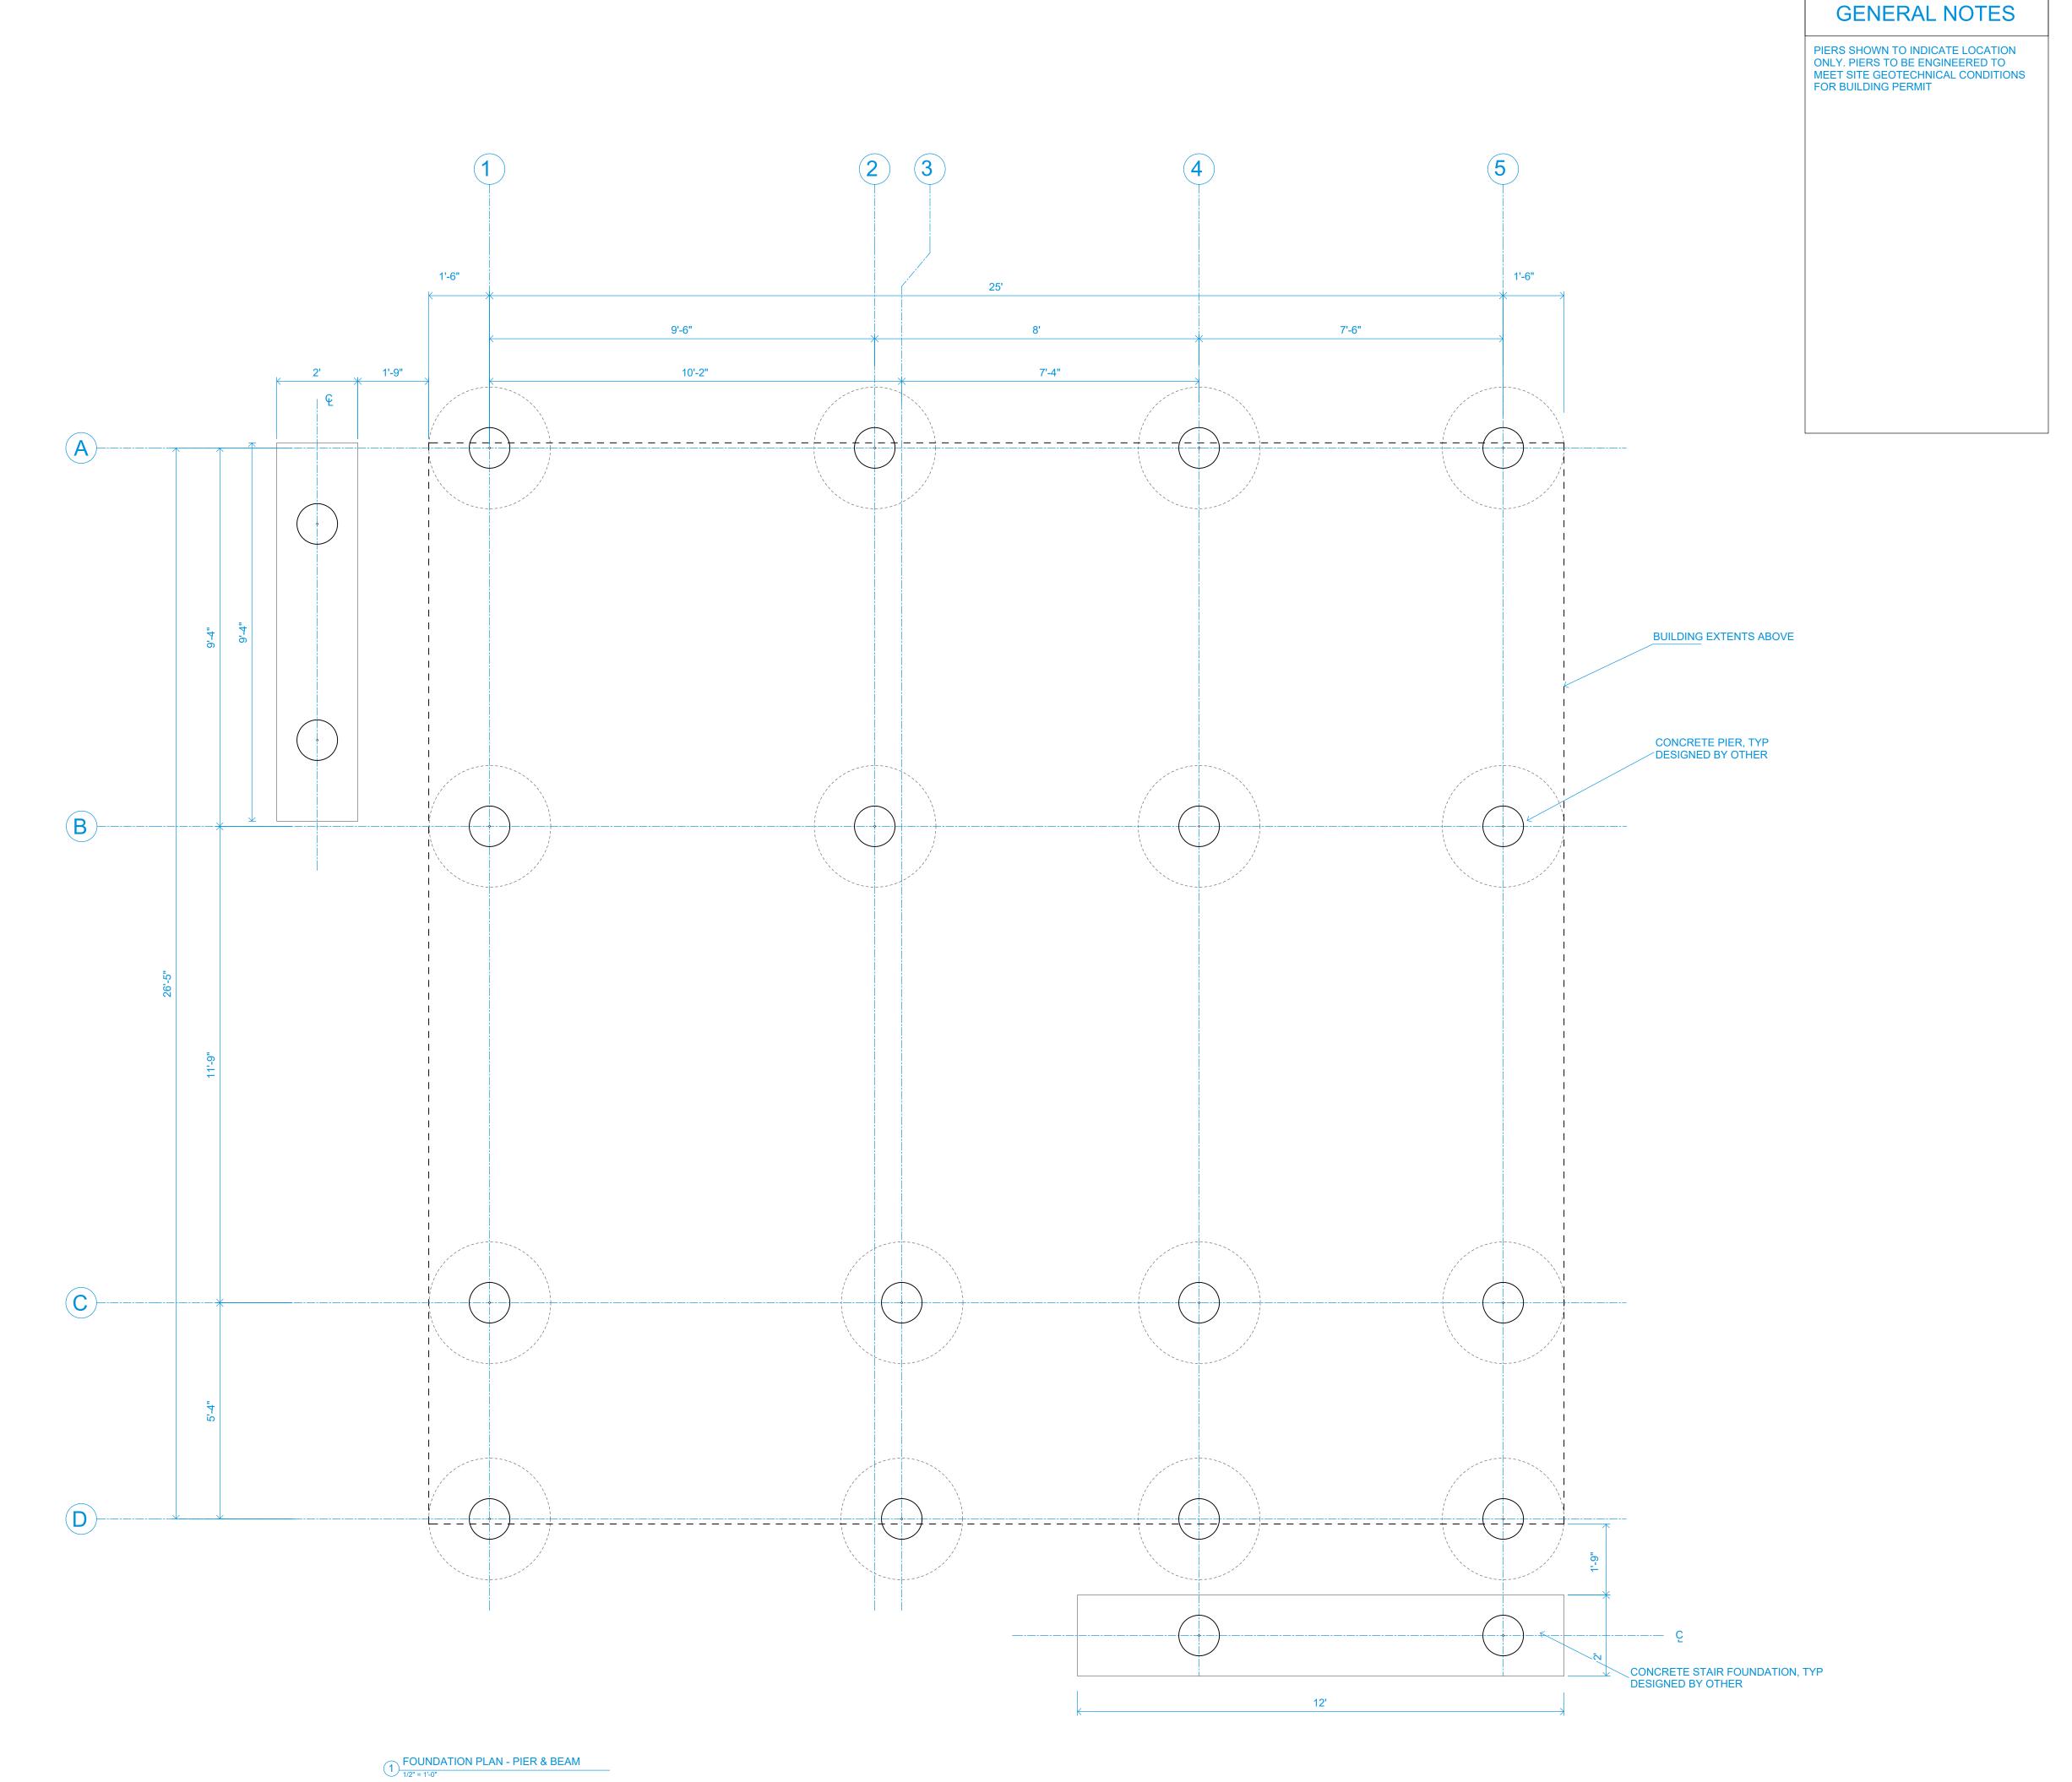

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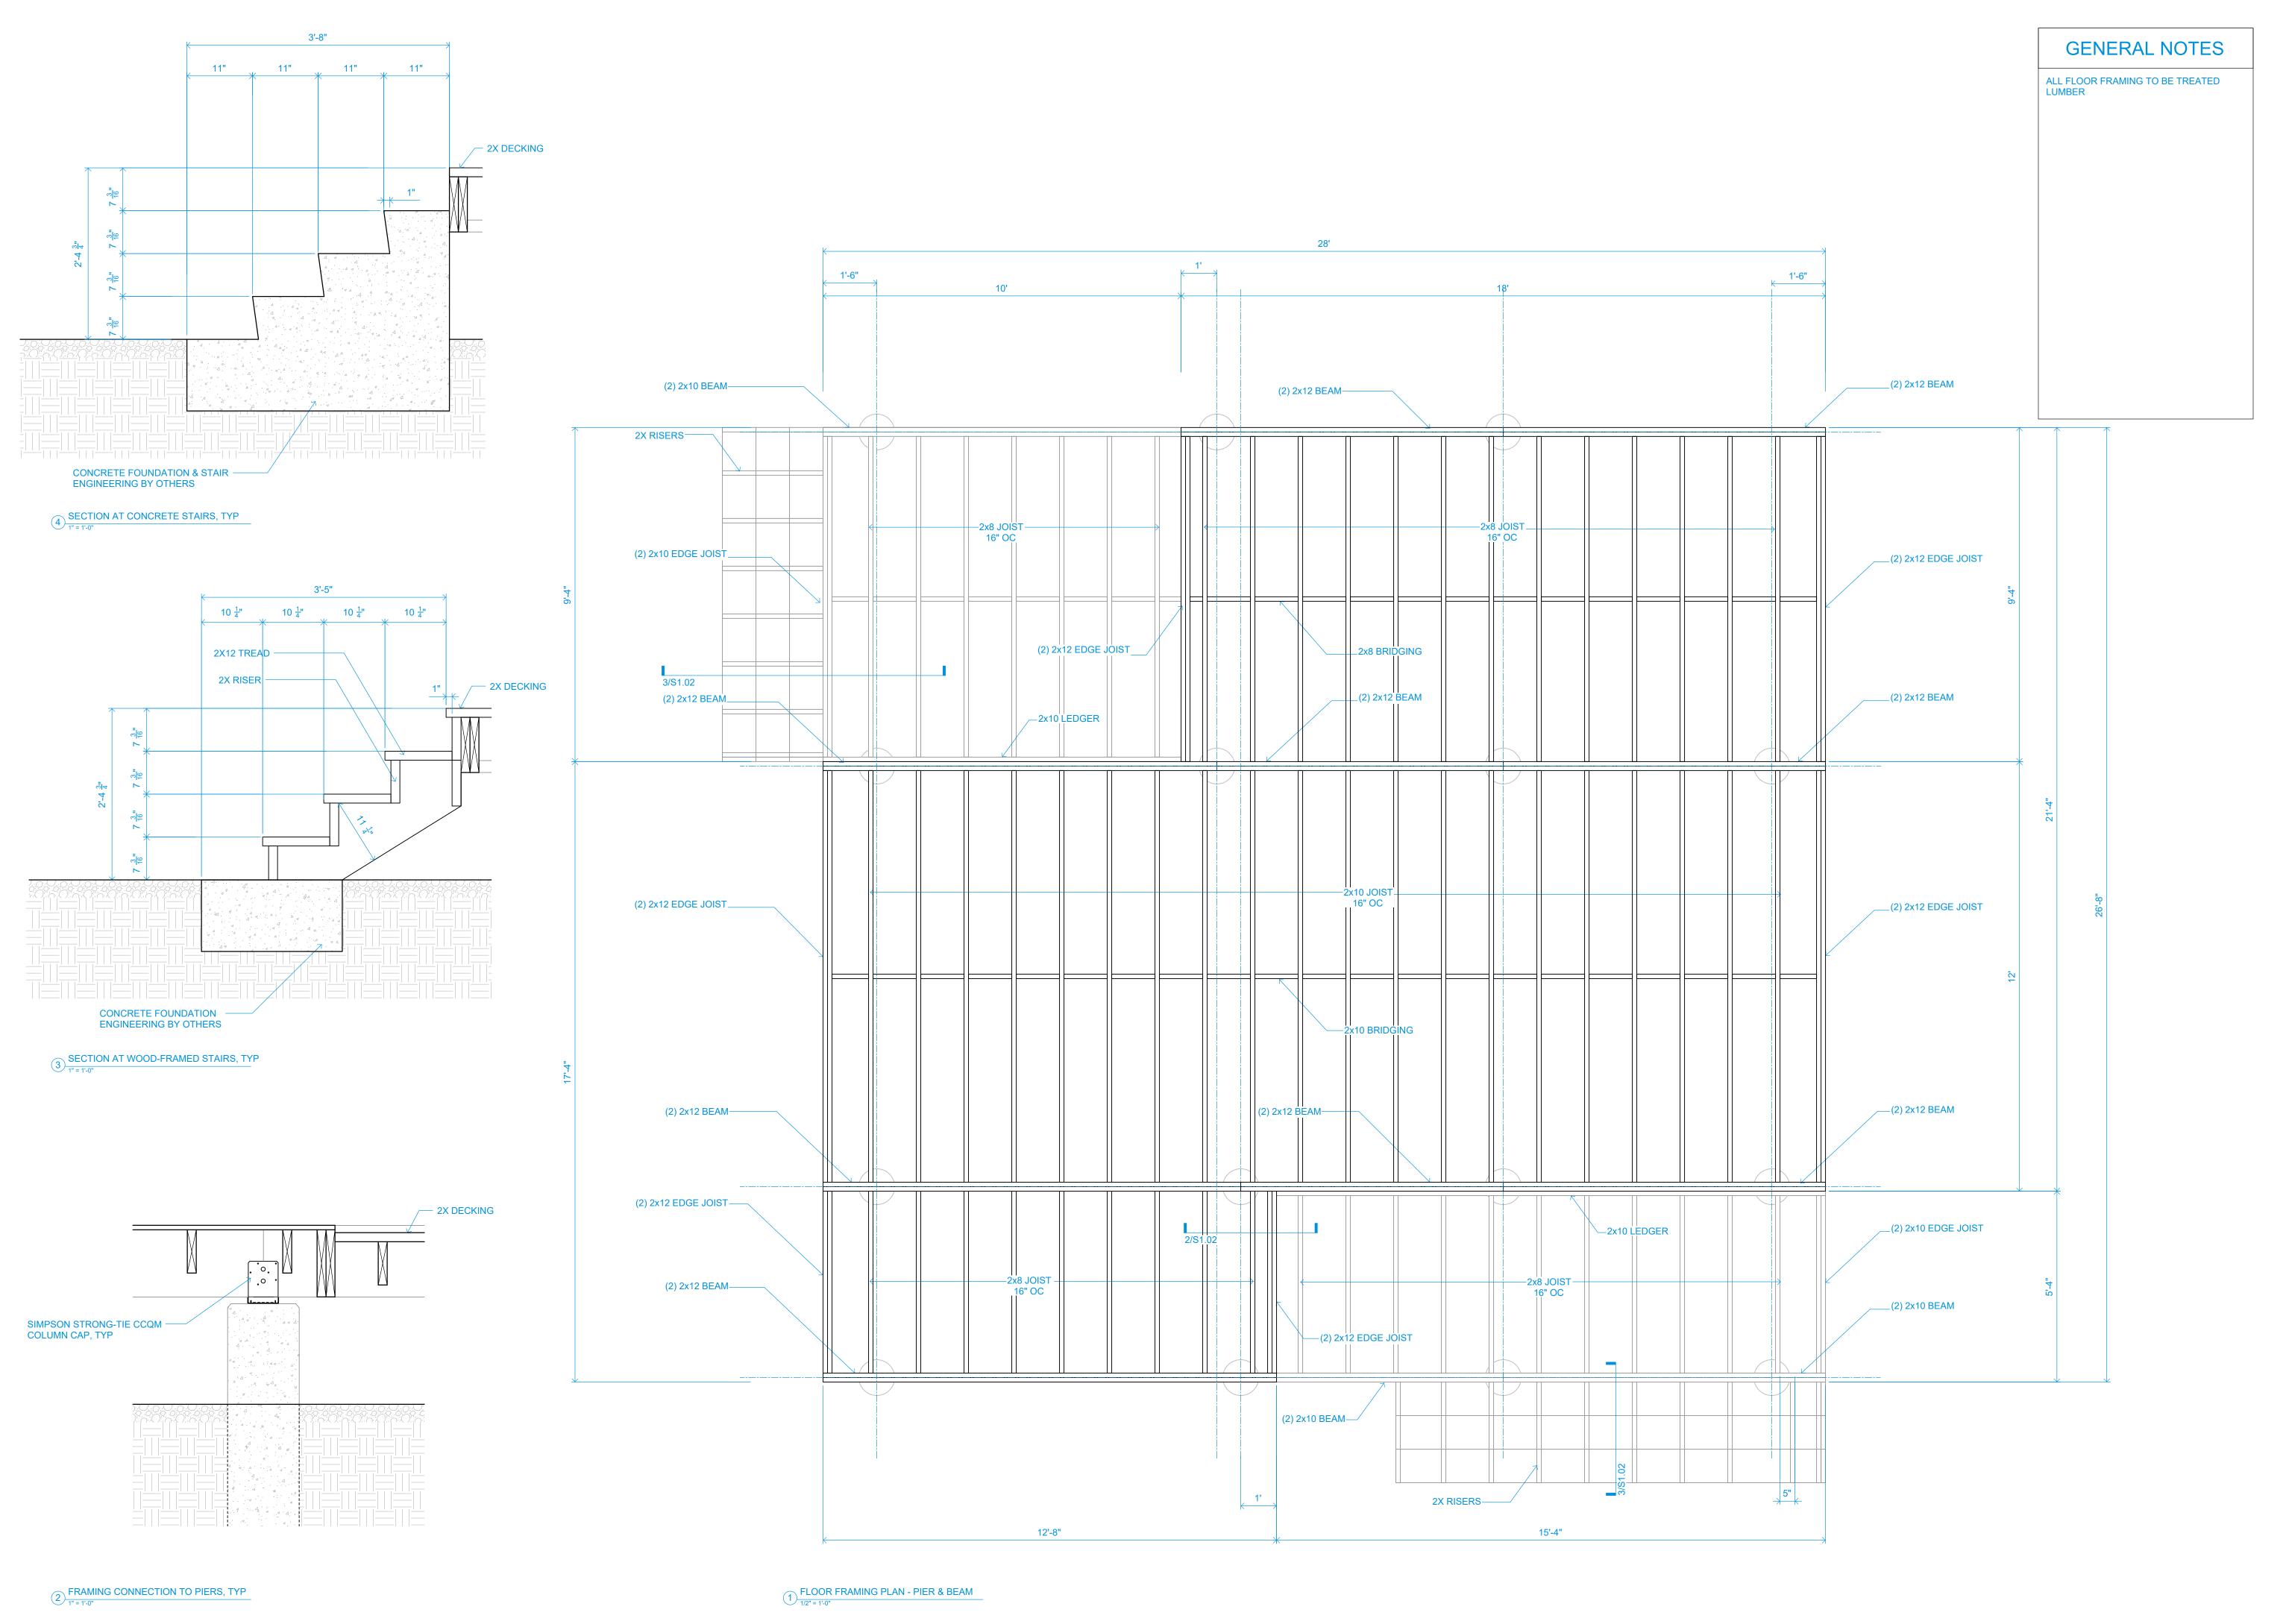
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SHEET CONTENTS

FOUNDATION PLAN - PIER & BEAM

SHEET NUMBER

S1.01



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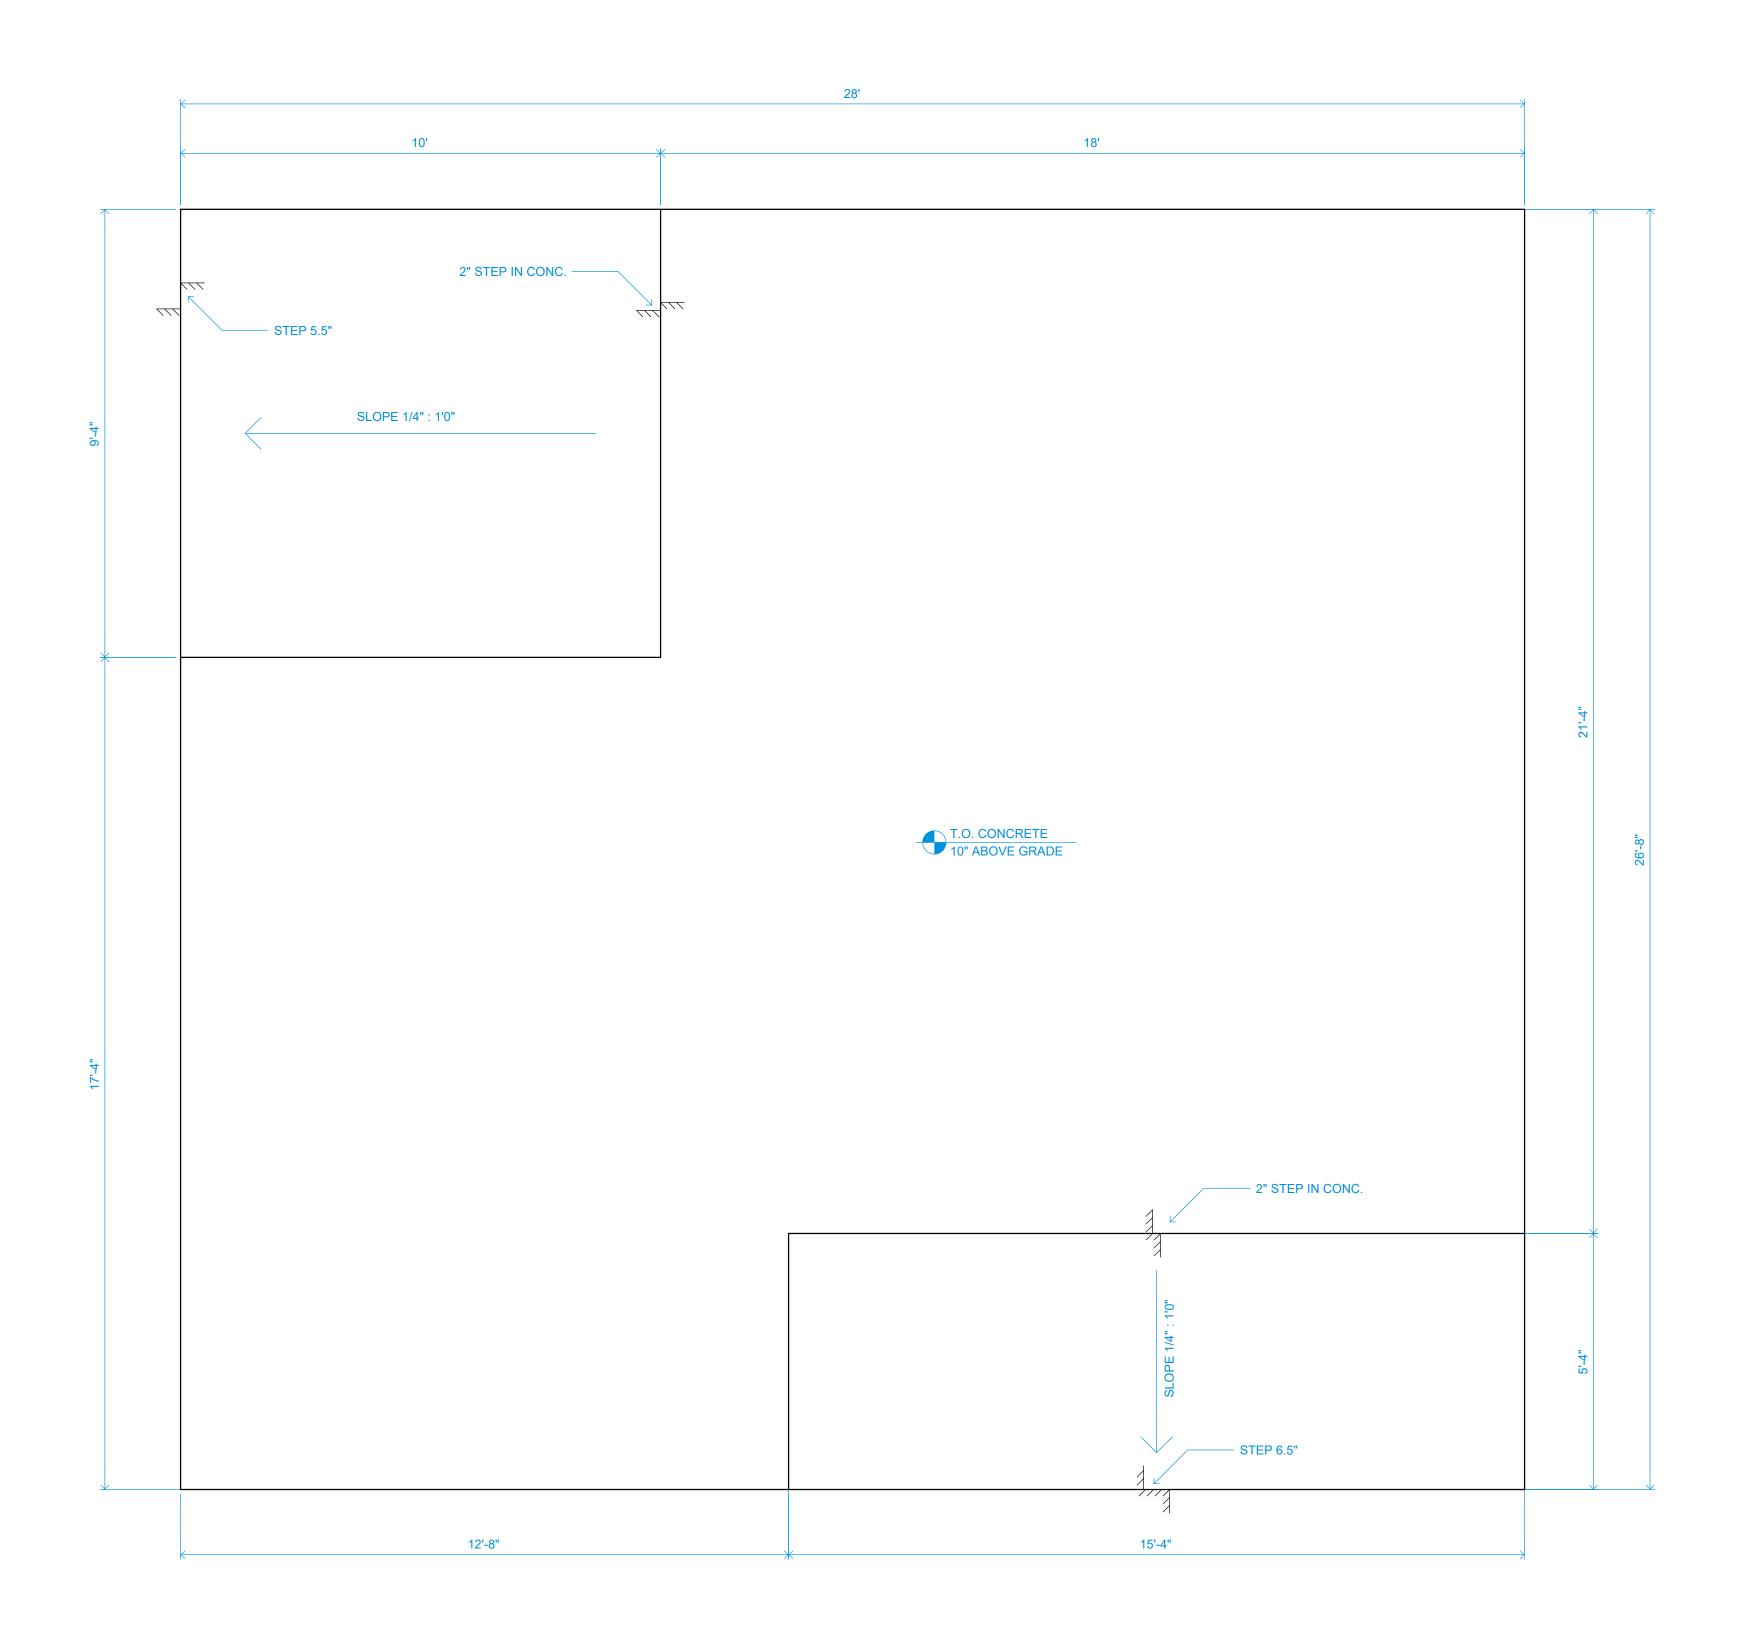
SCALE 1/2" = 1' - 0"

SHEET CONTENTS

FLOOR FRAMING PLAN - PIER & BEAM

SHEET NUMBER

S1.02



NOTES

SLAB ON GRADE FOUNDATION SHOWN AS AN ALTERNATE TO PIER & BEAM FOUNDATIONS (BASIS OF DESIGN)

DESIGN AND ENGINEERING OF
CONCRETE FOUNDATIONS TO BE
COMPLETED BY OTHERS. DIMENSIONAL
INFORMATINO SHOWN ONLY FOR
REFERENCE AND COORDINATION WITH
WOOD-FRAMED STRUCTURE

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DOUBLE-HOUSE


SHEET CONTENTS

ALT CONCRETE FOUNDATION PLAN

SHEET NUMBER

S1.10

1 ALT CONCRETE FOUNDATION PLAN
1/2" = 1'-0"

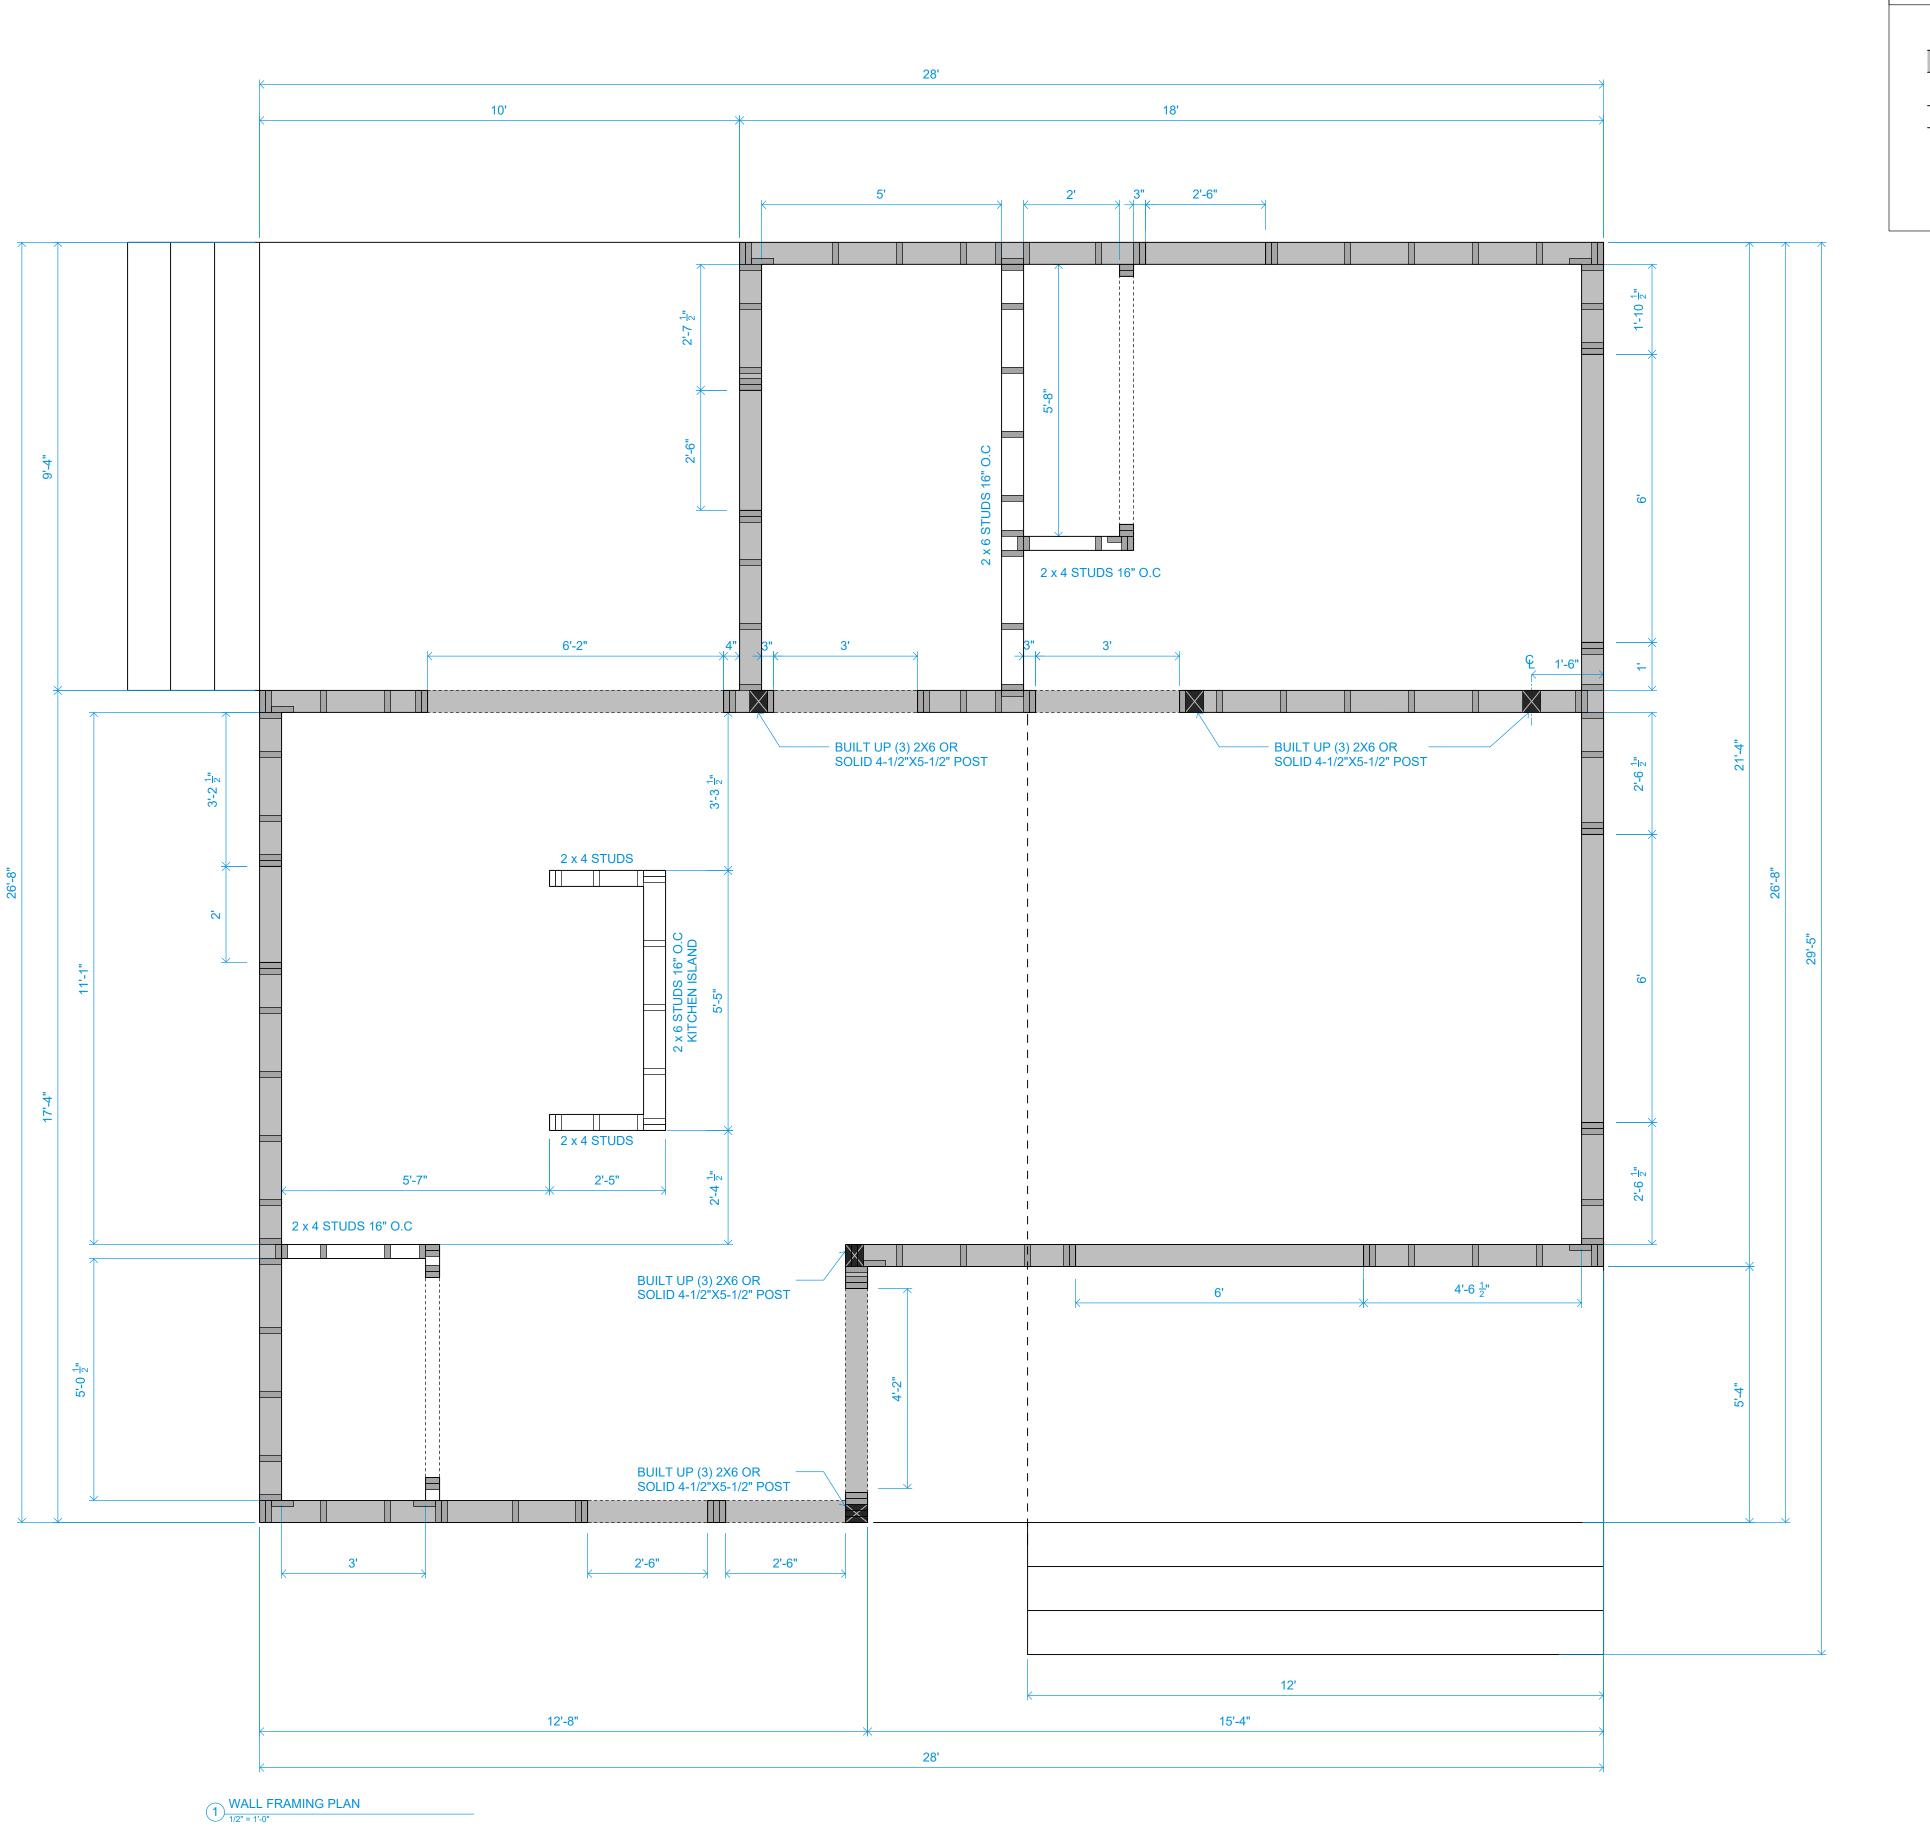

GENERAL NOTES

DIMENSIONS TO OUTSIDE OF FRAMING

WALL TYPE KEY

BEARING WALL
2X6 STUDS 16" OC

NON-BEARING WALL

2X6 OR 2X4 STUDS 16"OC
AS INDICATED

BUILT UP (3) 2X6 OR

BUILT UP (3) 2X6 OR
SOLID 4-1/2"X5-1/2" POST

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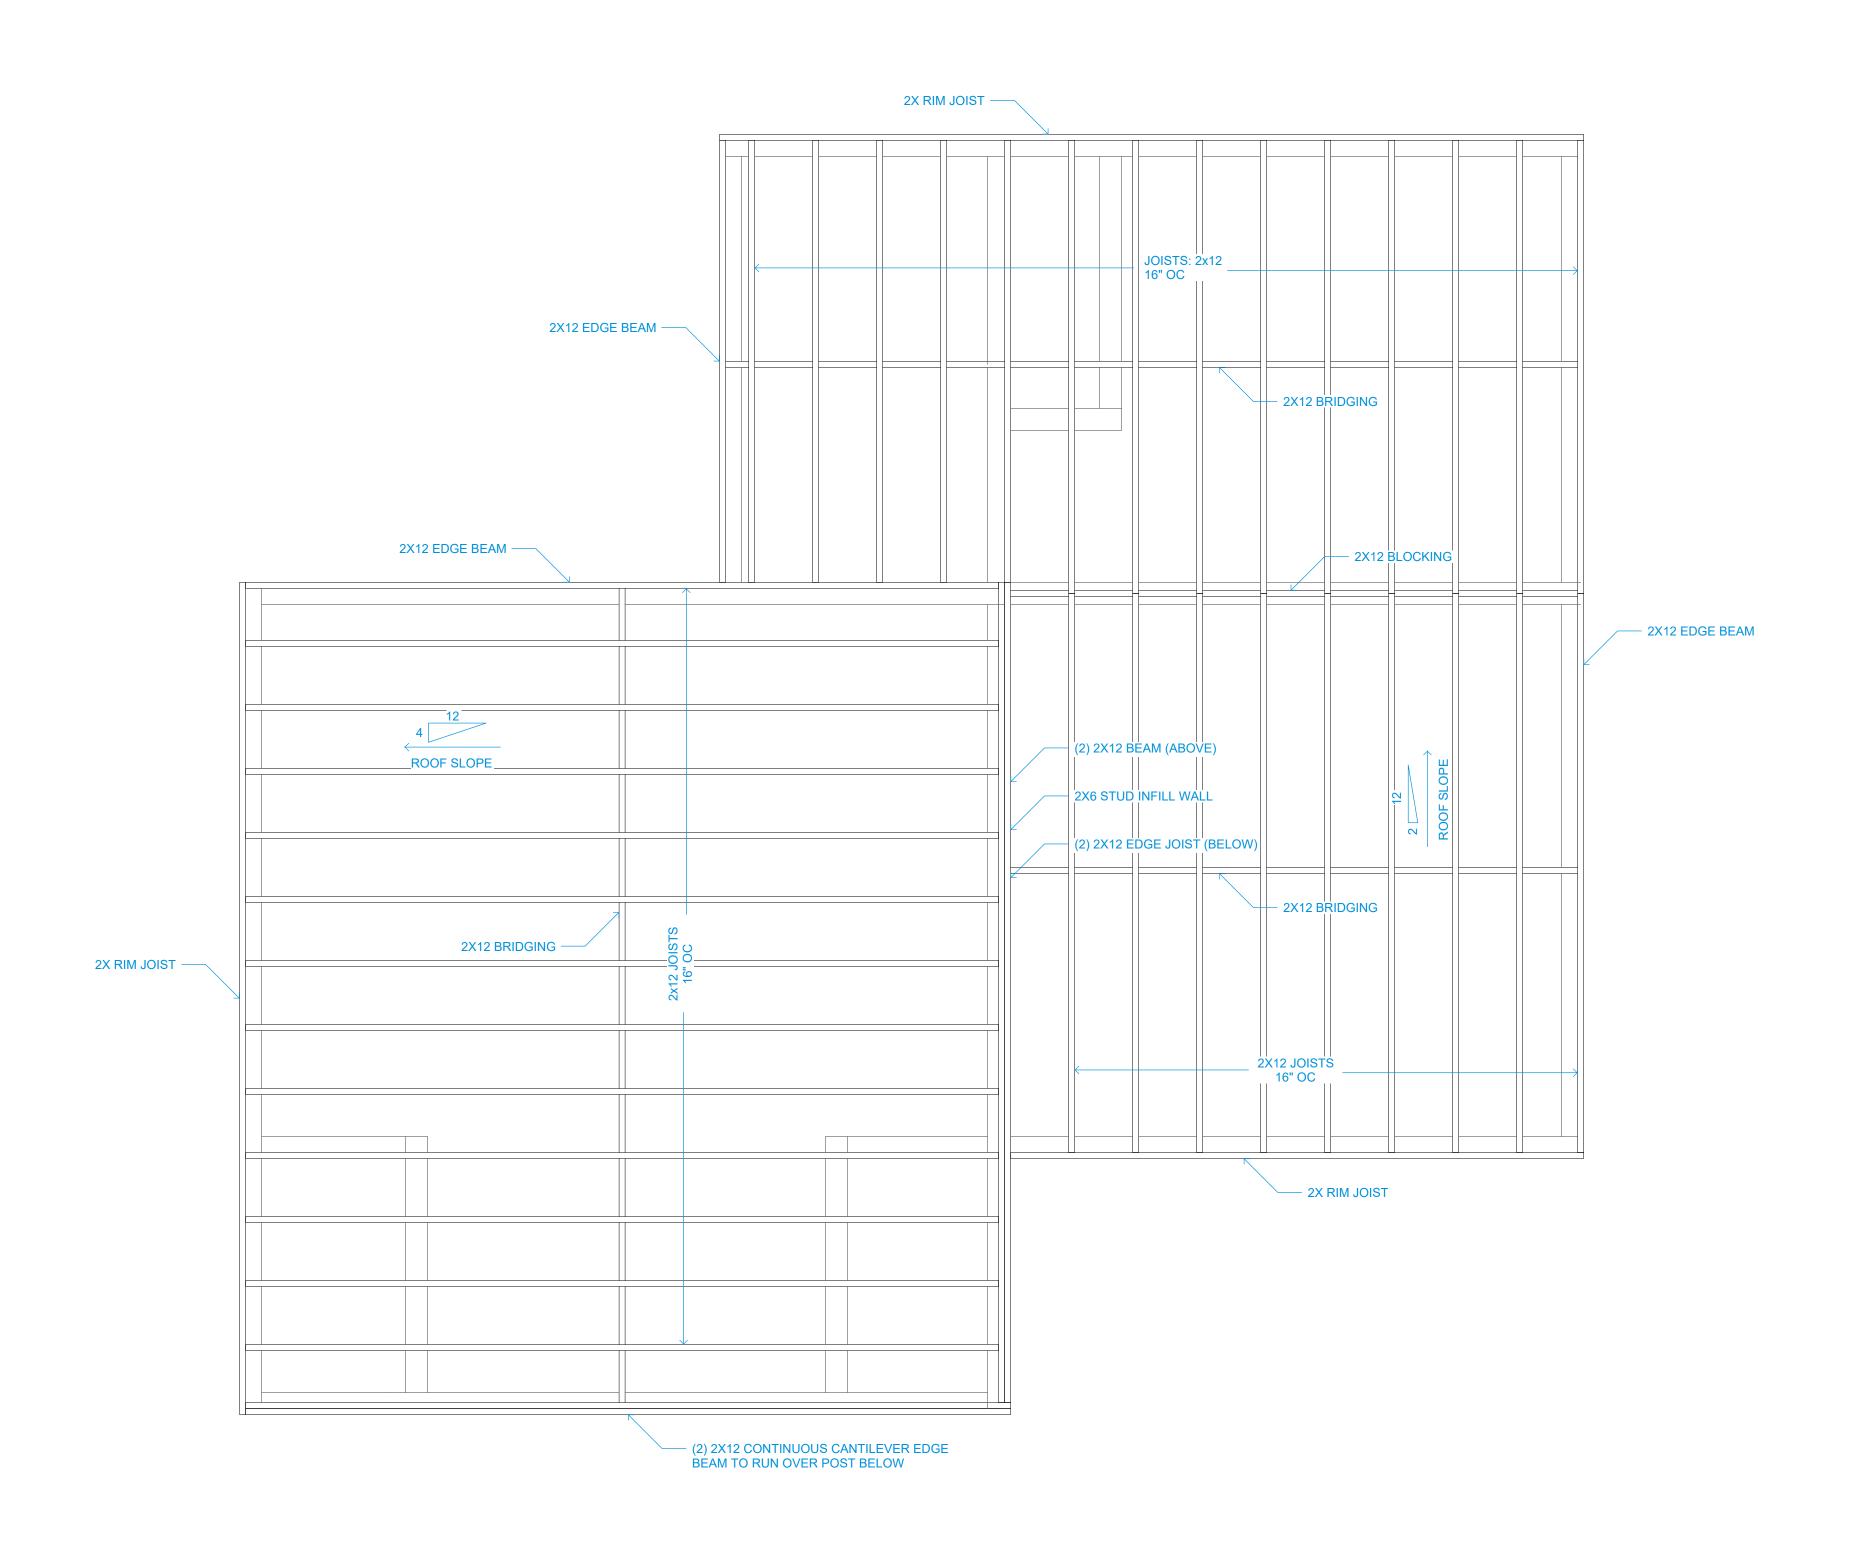
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SHEET CONTENTS

WALL FRAMING PLAN

SHEET NUMBER

S1.11



1 ROOF FRAMING PLA

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SHEET CONTENTS

ROOF FRAMING PLAN

SHEET NUMBER

S1.12

LIGHTING FIXTURE SCHEDULE						
MARK	FINISH	TYPE	QTY	DESCRIPTION		
R			10	LED POT LIGHT		
T			1	TRACK LIGHT		
Ю			1	WALL MOUNT FIXTURE		
W			1	LED POT LIGHT (WET LOC.)		
0			1	LED POT LIGHT (OUTDOOR)		
HO			3	WALL MOUNT FIXTURE (OUTDOOR)		
			2	CEILING FAN WITH LIGHT		
S			2	COMBINED SMOKE & CO ALARM		

ELECTRICAL SYMBOLS

SIMPLEX 240V OUTLET, WALL

DUPLEX OUTLET (OR H-BOX AT EQUIP. AS NECESSARY)

→ WALL SWITCH

S WIRED SMOKE & CARBON MONOXIDE DETECTOR


CENTER LINE

EXHAUST FAN

NOTES

1. ALL SWITCHES TO BE INSTALLED 36" A.F.F.

2. OUTLETS IN BATHROOM, CLOSET, AND KITCHEN TO BE GFCI.
3. SMOKE/CARBON MONOXIDE DETECTORS TO BE HARDWIRED WITH BATTERY BACKUP.
4. INT. RECESSED LIGHTING SEALED AT INT. FINISH.
5. ALL INSTALLED LIGHTING TO BE LED.

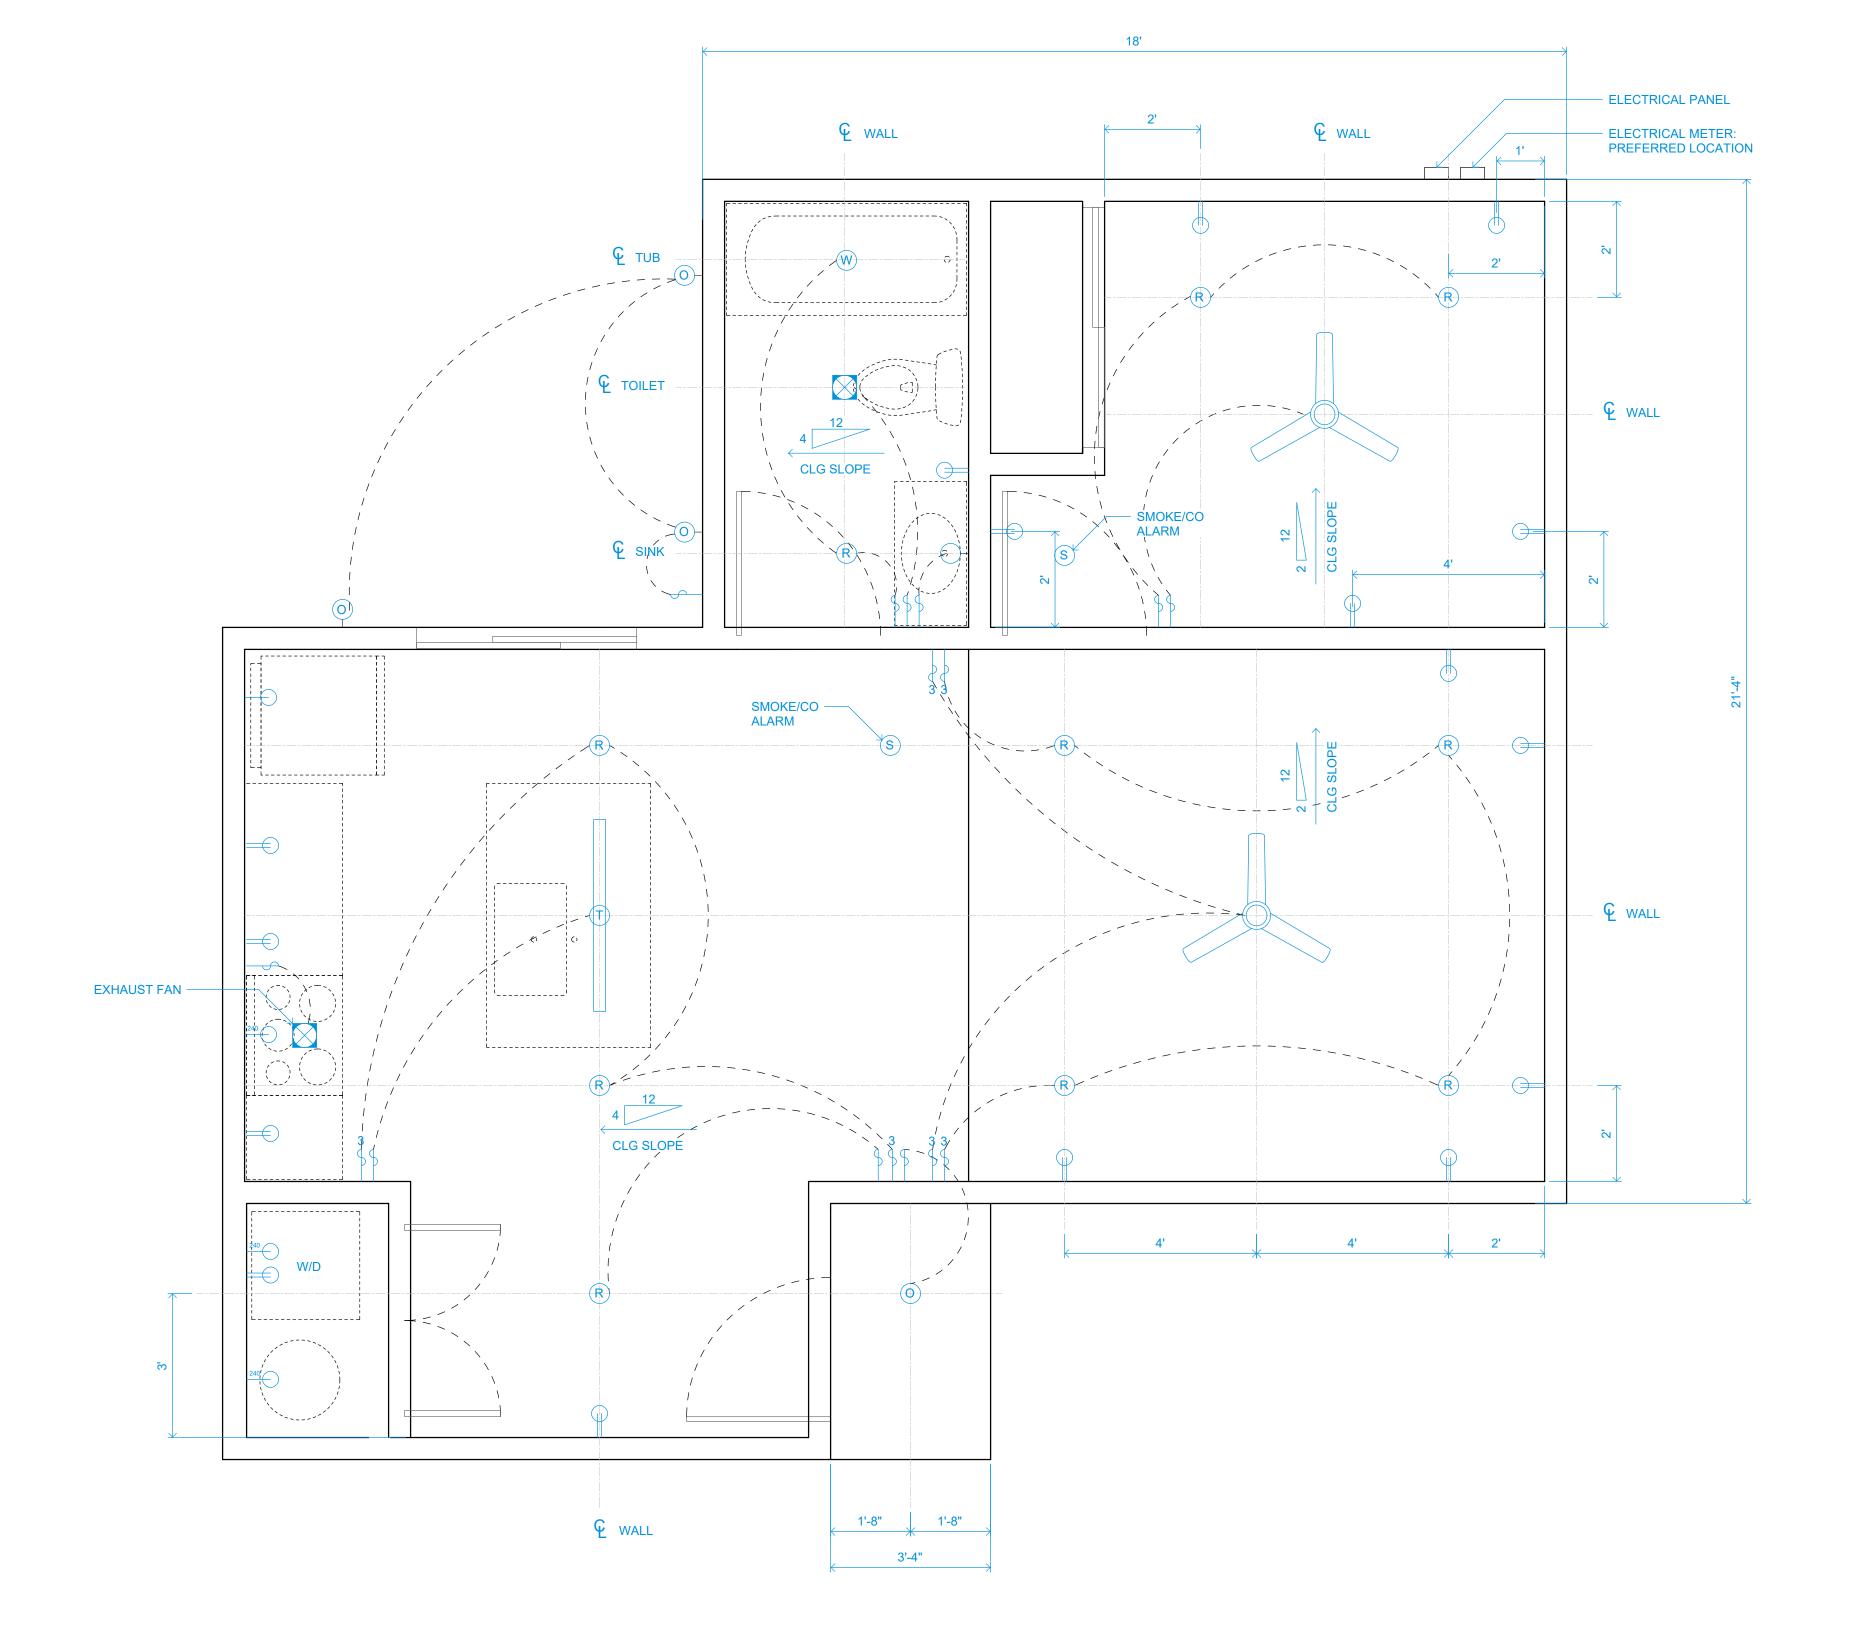

ADAM BERMAN CONSTRUCT

RICE ARCHITECTURE

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SHEET CONTENTS

FOUNDATION PLAN - PIER & BEAM

SHEET NUMBER

1 ELECTRICAL REFLECTED CEILIGN PLAN
1/2" = 1'-0"

WALL MOUNTED HEAT PUMP BATHROOM EXHAUSTS TO ROOF - DUCTLESS, WALL-MOUNTED AC UNIT IN RECESSED NICHE OVER CLOSET. RUN CONDENSATE TO BATHROOM SINK. DUCTLESS, WALL-MOUNTED AC UNIT ABOVE, RUN CONDENSATE TO BATHROOM SINK. KITCHEN EXHAUST -TO ROOF DRYER VENT ----

SYMBOL

(D) SANITARY DRAIN

(H) HOT WATER

(C) COLD WATER (AC) AIR CONDITIONING CONDENSATE

S SEWER CLEANOUT

MOSE BIB

WH WATER HEATER THERMOSTAT

EXHAUST FAN

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CONSTRUCT

RICE ARCHITECTURE

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SHEET CONTENTS

PLUMBING & MECHANICAL PLAN

SHEET NUMBER

MP1.00